

## NINE PEAKS

1590 PIERCY AVENUE, COURTENAY



## DRAWING INDEX ARCHITECTURAL

- P1 SITE PLAN
- P2 FOUNDATION PLAN
- P3 FLOOR PLANS
- P4 ROOF PLAN
- P5 SECTIONS
- **P6 ELEVATIONS**



**PERSPECTIVE** 



1160 4TH ST., COURTENAY BRITISH COLUMBIA V9N 1H8

### DUPLEX DETAILED DESIGN

TO SCALE ON 36X24
PRINT FORMAT ONLY

COVER SHEET REVISION

0.0

# COURTENAY DISTRICT, PLAN 4764 TOPOGRAPHIC SURVEY PLAN 1590 PIERCY AVENUE, COURTENAY SCALE 1: 150 (METRIC) PROJECT DATA ZONING R2 (TO BE RE-ZONED R3) LOT AREA 0.5 ACRES (2030.5 SQ M)

ITEMS	PERMITTED	PROPOSED
LOT COVERAGE /FAR	0.4	0.32


LOT COVERAGE TOTAL (SQ M) 812.2 651.9 HEIGHT (M) 10 6.1

#### SETBACKS (M)

FRONT	MIN 7.5	7.5
REAR	MIN 7.5	7.5
SIDE LEFT	MIN 1.5	3.3
SIDE RIGHT	MIN 1.5	1.7

#### FLOOR AREAS

EXTERIOR	FLOOR	AREA	OF	2	DWE	LLINGS	S	BUILDING	(SQ	M)
EXTERIOR	FLOOR	AREA	OF	3	DWE	LLINGS	S	BUILDING	(SQ	M)
EXTERIOR	FLOOR	AREA	OF	4	DWE	LLINGS	S	BUILDING	(SQ	M)
EXTERIOR	FLOOR	AREA	IN	T	DTAL	(SQ N	M)	1		
(9)ENTRIE	ES IN	ΓΟΤΑL	(S0	1 G	۷)					
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FILE: 2211-80169-08

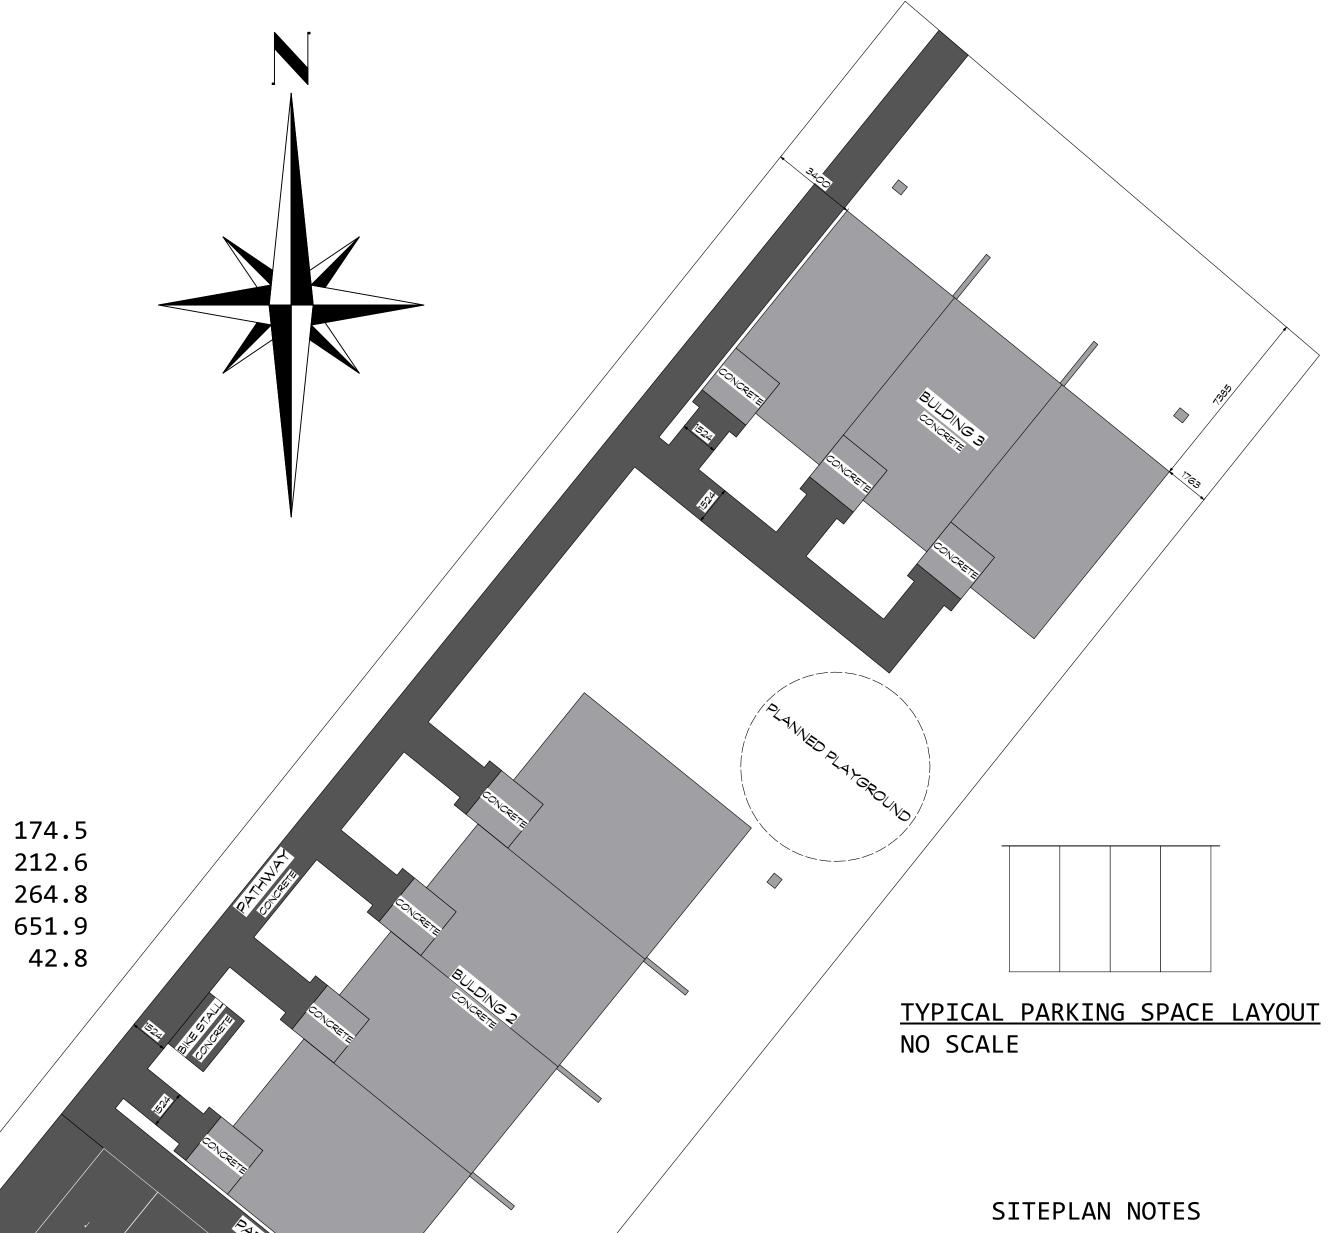


OFF-STREET PARKING	REQUIRED	<u>PROPOSED</u>
SPACES (PER DWELLING INCL.10% VISITOR PARKING)	14 (1.5)	10 (1.1)


BICYCLE PARKING ADDITION
LONG TERM PARKING SPACES
SHORT TERM PARKING SPACES

OTHER PARKING LOT SPECIFICATIONS SHALL FOLLOW DIVISION 7, BYLAW 2500 (2007) REQUIRMENTS

SEE PARKING STUDY ISSUED AND SIGNED BY WATT CONSULTING GROUP, FILE NUMBER 2785.B01; MARCH 30, 2020

- 1. CARRY ON ALL SITE WORK SHOWN ON OR READILY INFEARABLE FROM THE PERMIT DRAWINGS; INCLUDING EXCAVATION, DEWATERING, BACKFILLING, ROUGH & FINISHED GRADING, BELOW-GRADE SERVICES, PLANTING, SODDING, FENCING, CURBING, PAVING, LINE MARKERS, SIGNAGE, ETC. CO-ORDINATE ALL WORK WITH THE SOIL REPORT & THE ITS ENGINEER. PROVIDE INSPECTIONS, TEST AND REPORTS, FOR ALL BEARING SURFACES, BACKFILL MATERIALS, AND COMPACTION.
- 2. LEGALLY DISPOSE OFF-SITE ALL EXCAVATED MATERIAL, & ITEMS REQUIRING REMOVAL.
- 3. PROTECT ALL EXISTING PUBLIC PROPERTY AND UTILITIES. PROVIDE HOARDINGS, BRACING, SHORING, COVERS, ETC. AS REQUIRED. CONTACT ALL REQUISITE MUNICIPAL AND UTILITY AUTHORITIES FOR LOCATES, AND CARRY OUT WORK TO THEIR APPROVAL. MAKE GOOD ANY DAMAGE.
- 4. DO NOT COVER-UP ANY WORK UNTIL PROPERLY INSPECTED BY THE PERTINENT CONSULTANT AND/OR AUTHORITY.
- 5. OBTAIN APPROVAL FROM GEOTECHNICAL / STRUCTURAL ENGINEER FOR ALL BEARING SURFACES, BACKFILL MATERIALS, AND COMPACTION.
- 6. SEE SURVEYOR'S PLAN FOR PROPERTY LINE DIMENSIONS AND DIRECTION.
- 7. SEE GEOTECHNICAL ENGINEER'S REPORT FOR SOIL / BEARING CONDITIONS.

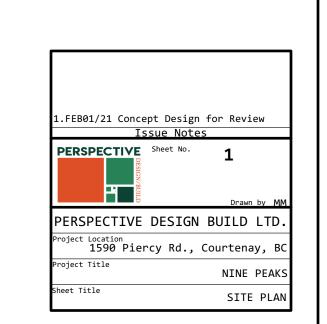

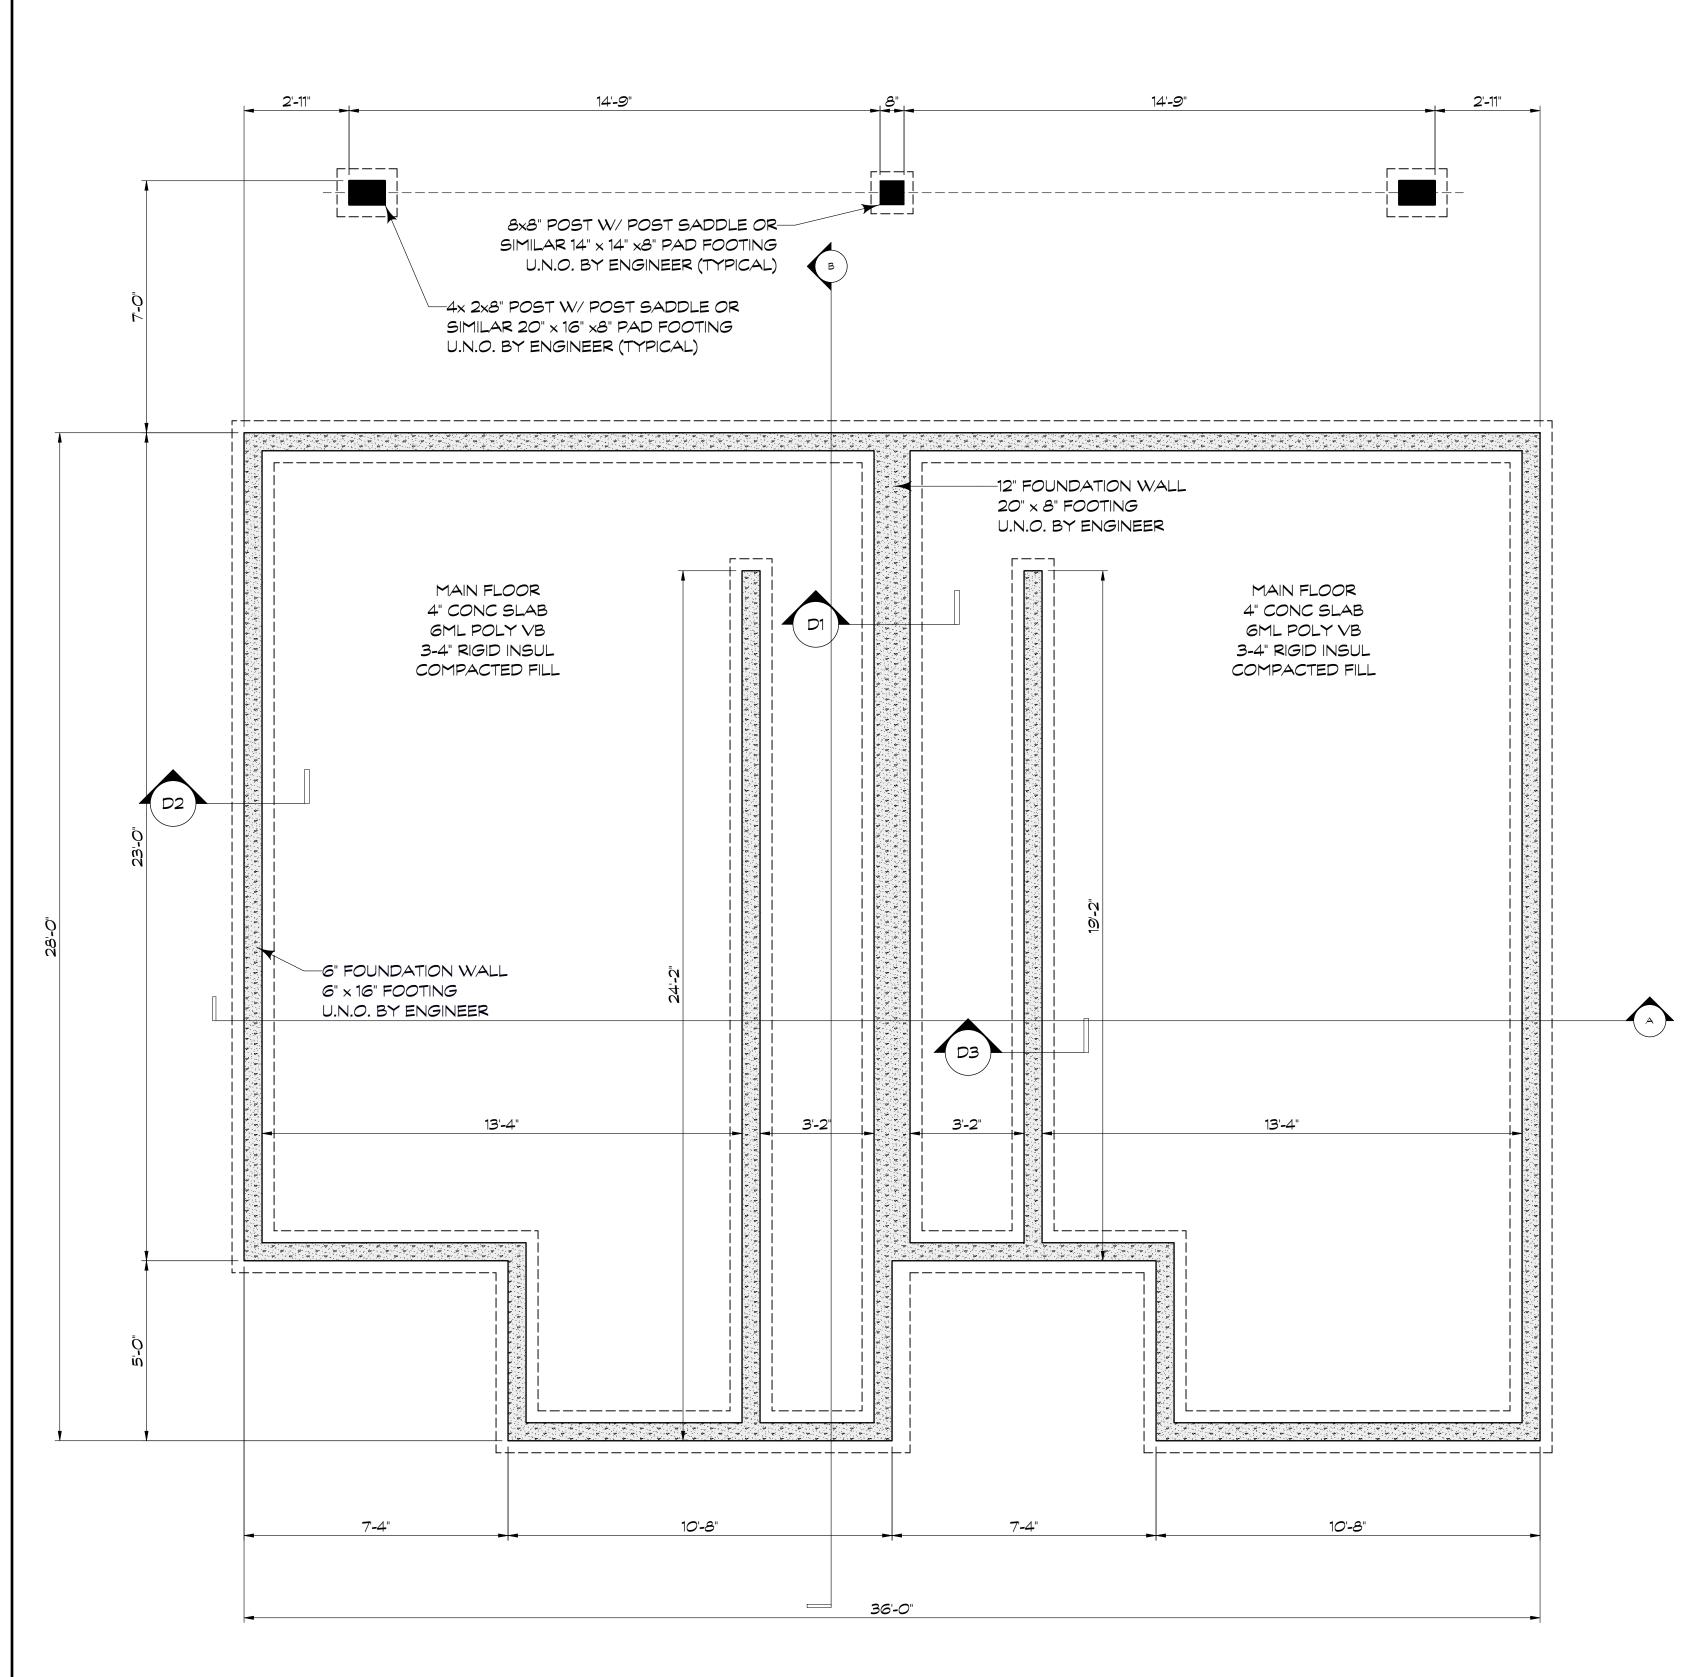

FOUNDATION PLAN SCALE: 3/8" = 1'-0"

~68 LINEAR FT PER DWELLING

ALL POINT LOADS MUST BE ASSESSED BY AN ENGINEER AND FOOTING SIZES INCREASE AS REQUIRED TO SUPPORT LOADS

#### NOTES:

#### GENERAL NOTES

- ALL WORK SHALL CONFORM TO CURRENT BUILDING CODES AND LOCAL BYLAWS

- WRITTEN DIMENSIONS TAKE PRECEDENCE OVER SCALED DRAWINGS

#### CONCRETE

- ALL CONCRETE TO HAVE MINIMUM COMPRESSIVE STRENGTH OF 20MPA AT 28 DAYS - FOOTINGS SHOWN ON THESE DRAWINGS HAVE BEEN DESIGNED FOR SOIL BEARING
- CAPACITY OF 2500 PSF. LOCAL CONDITIONS AND / OR LOCAL PRACTICE MAY NECESSITATE A MORE STRINGENT FOOTING DESIGN WHICH, MAY REQUIRE
- CONFIRMATION BY A CERTIFIED STRUCTURAL ENGINEER. THIS WILL BE THE RESPONSIBILITY OF THE OWNER / CONTRACTOR TO PROVIDE.
- CONCRETE FOOTINGS MUST BE PLACED ON UNDISTURBED OR COMPACTED SOIL TO AN ELEVATION BELOW FROST PENETRATION OR ALTERNATIVE METHOD SHALL BE USED TO
- ENSURE INSULATION OF FOUNDATION AS PER LOCAL BUILDING CODE - ALL CONCRETE AND MASONRY FOUNDATION WALLS EXCEEDING LIMITS STATED IN
- BUILDING CODES REQUIRE DESIGN BY A REGISTERED STRUCTURAL ENGINEER
- ALL FOOTINGS TO HAVE 2 ROWS OF MIN. NO. 4 REBAR 3" CLEAR FROM SIDE AND
- ALL WOOD CONTACTING CONCRETE TO BE SEPARATED WITH APPROVED MATERIAL

#### STRUCTURAL

- ALL WOOD FRAMING TO BE #2 OR BETTER DOUGLAS FIR OR SPRUCE
- ALL LINTELS TO BE 2-2X10 #2 DOUGLAS FIR OR BETTER UNLESS OTHERWISE NOTED
- LAMINATE STUDDING UNDER ALL LOAD BEARING POINTS - JOISTS ARE TO BE DOUBLED UNDER PARTITIONS
- ALL ENGINEERED COMPONENTS TO BE INSTALLED TO MANUFACTURES SPECS.

#### PLUMBING


- PLUMBING FIXTURES AND FITTINGS SHALL MEET THE STANDARDS NOTED BELOW
- A) WATER CLOSET = 1.6 GAL PER FLUSH B) SHOWER HEAD = 2.5 GPM MAX
- C) LAVATORY FAUCETS = 2.2 GPM MAX
- D) SINK FAUCETS = 2.2 GPM MAX TITLE 24, VCBC, UPC


#### EGRESS WINDOWS (BEDROOMS)


- FINISHED SILL 59" ABOVE FLOOR MAX.
- NET OPENING TO BE 3.77 SQUARE FEET MINIMUM, WITH NO DIMENSION LESS THAN 15"

#### MECHANICAL AND VENTILATION

- BUILDING MUST BE PROVIDED WITH MECHANICAL VENTILATION DESIGN BY OTHERS
- ATTIC TO BE VENTED MINIMUM 1:300 OF AREA
- ONE HALF OF ROOF VENTS TO BE LOCATED IN UPPER PORTION OF ATTIC SPACE, AT LEAST 3'-O" HIGHER THAN EAVE OR CORNICE VENTS
- 22" x 30" MIN. ATTIC ACCESS. INSULATE AND WEATHER STRIP DOOR. 30" MIN. HEAD CLEARANCE

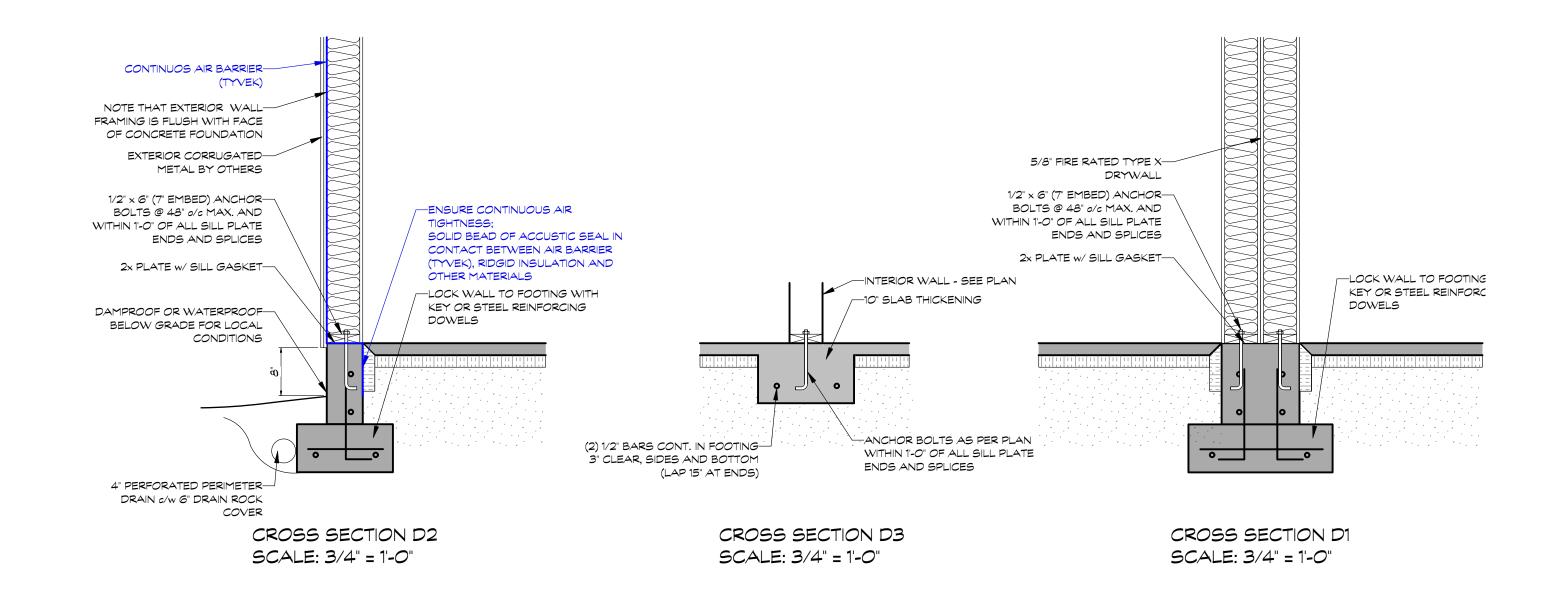

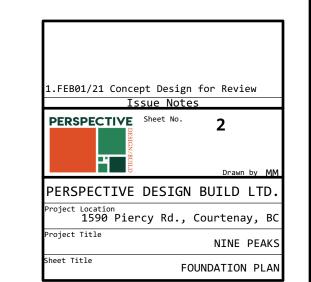


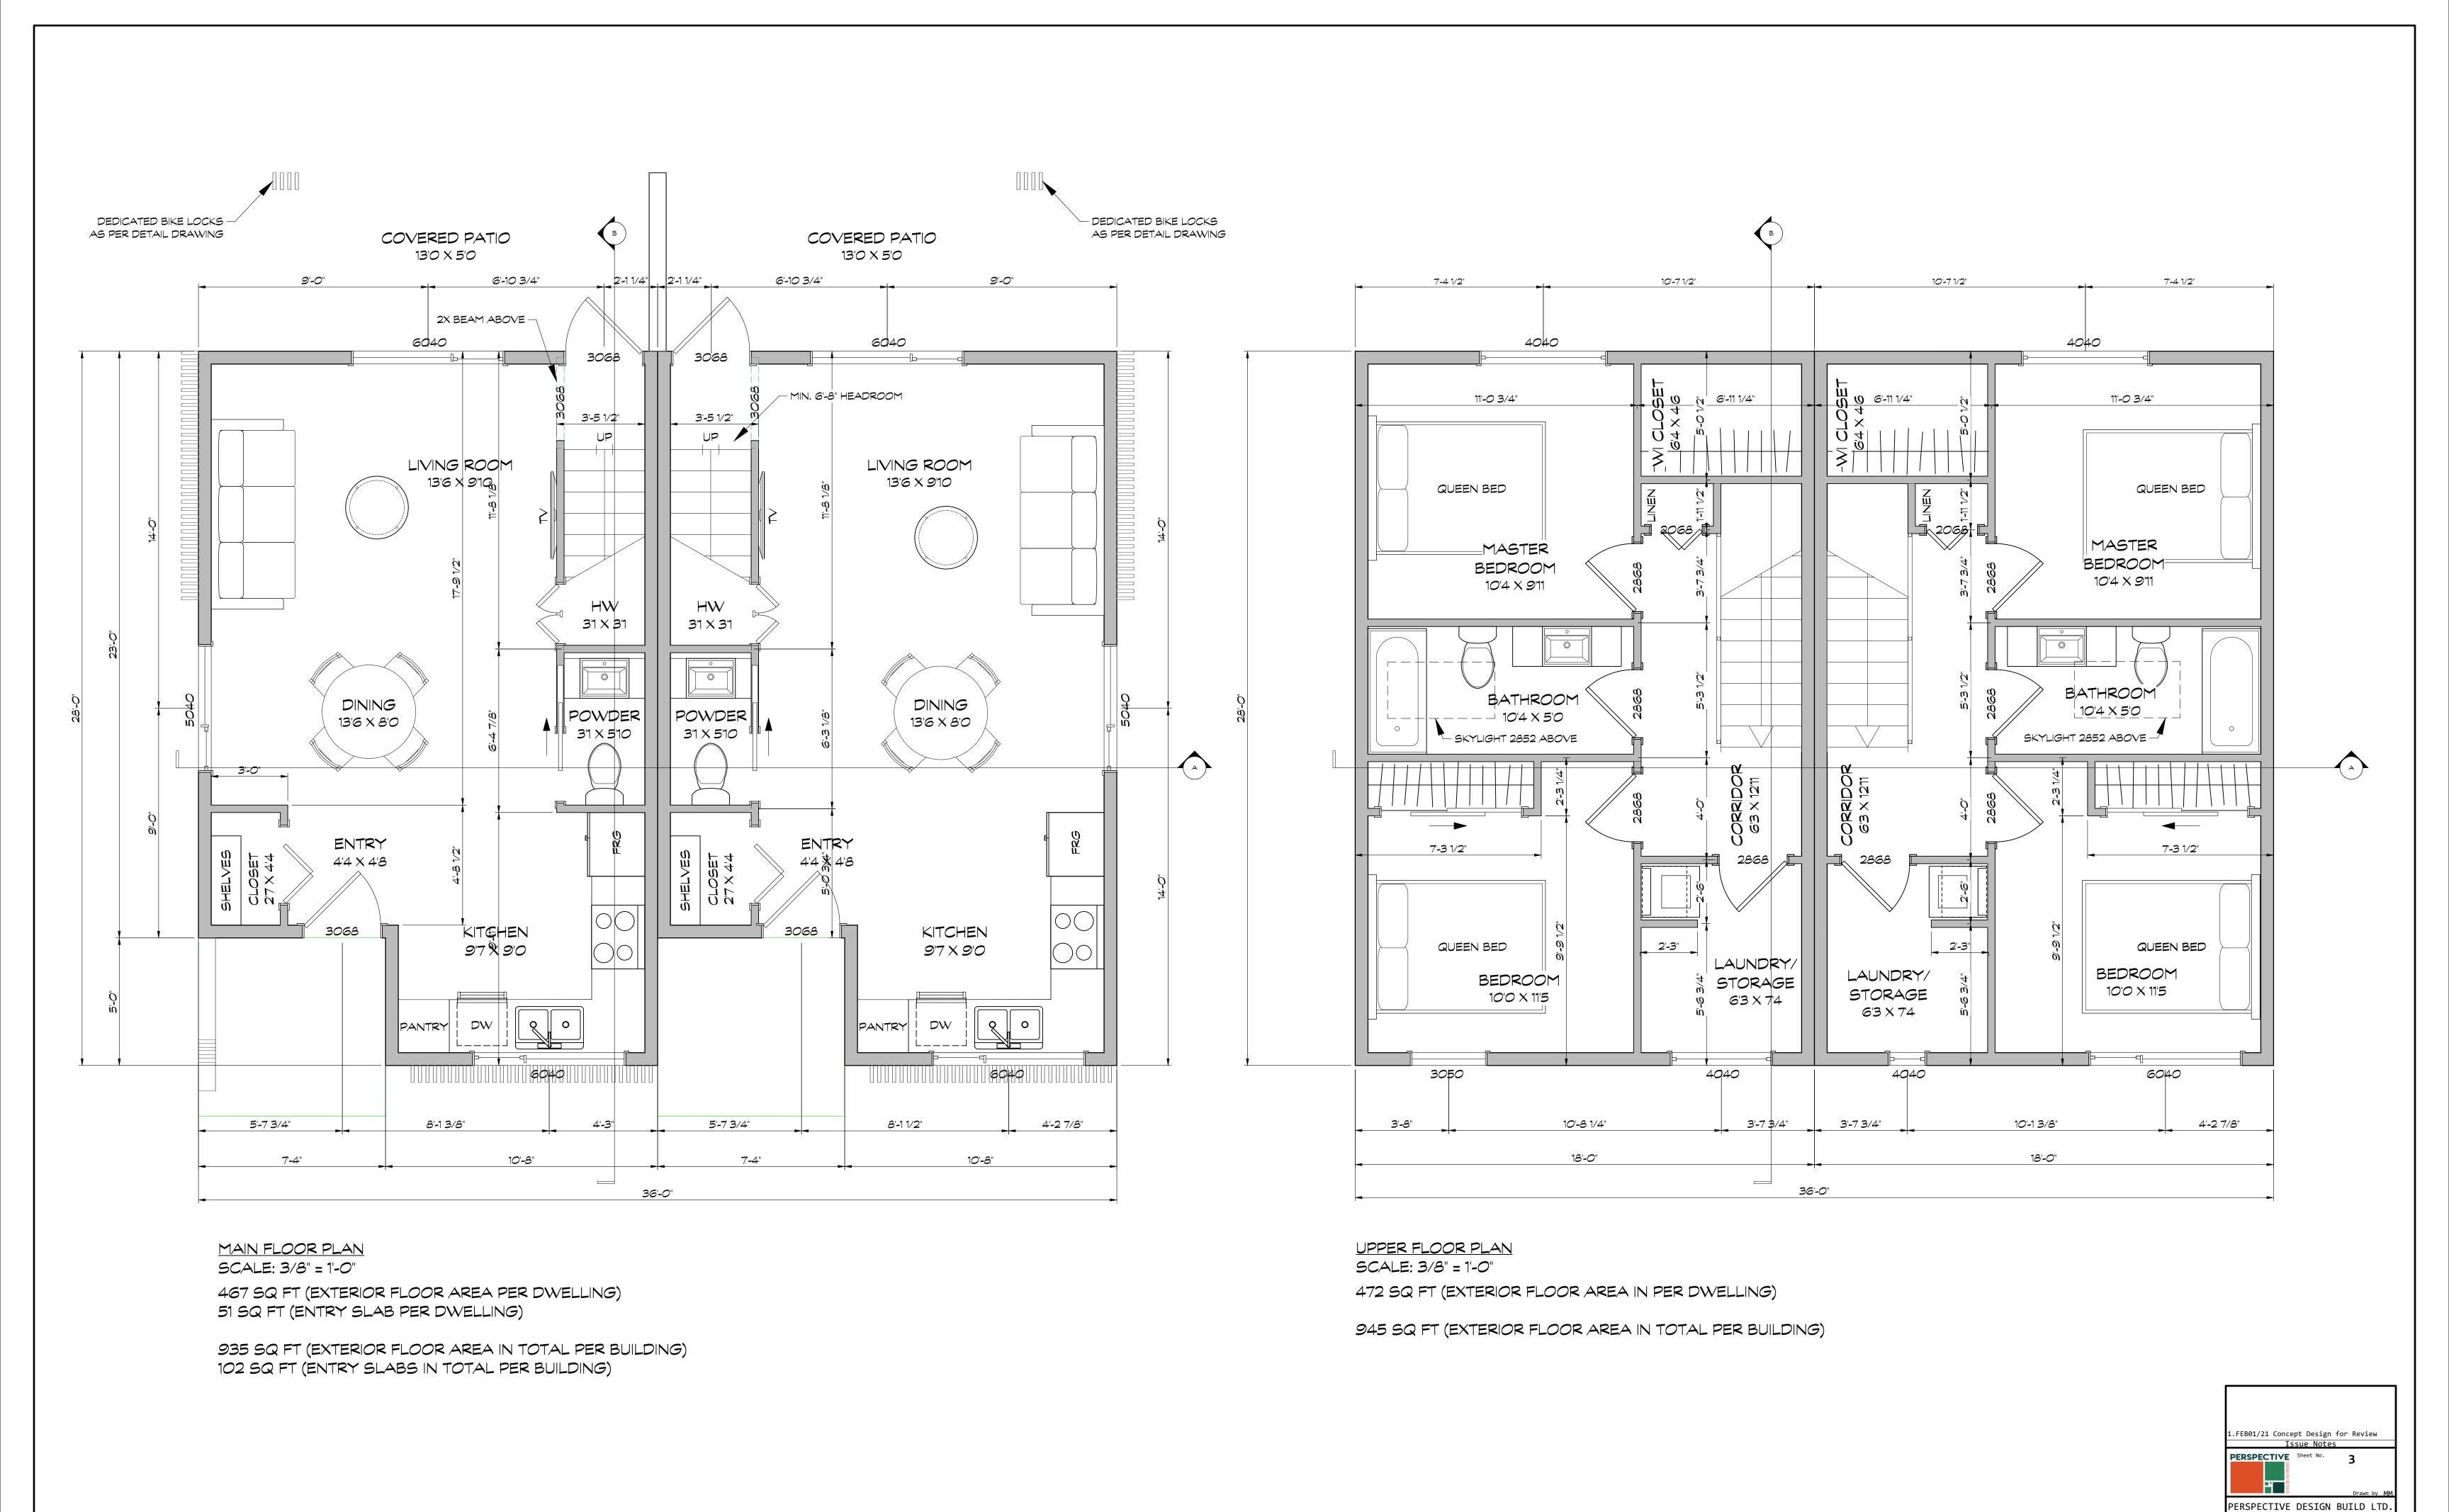

1590 Piercy Rd., Courtenay, B


NINE PEAKS


FLOOR PLANS

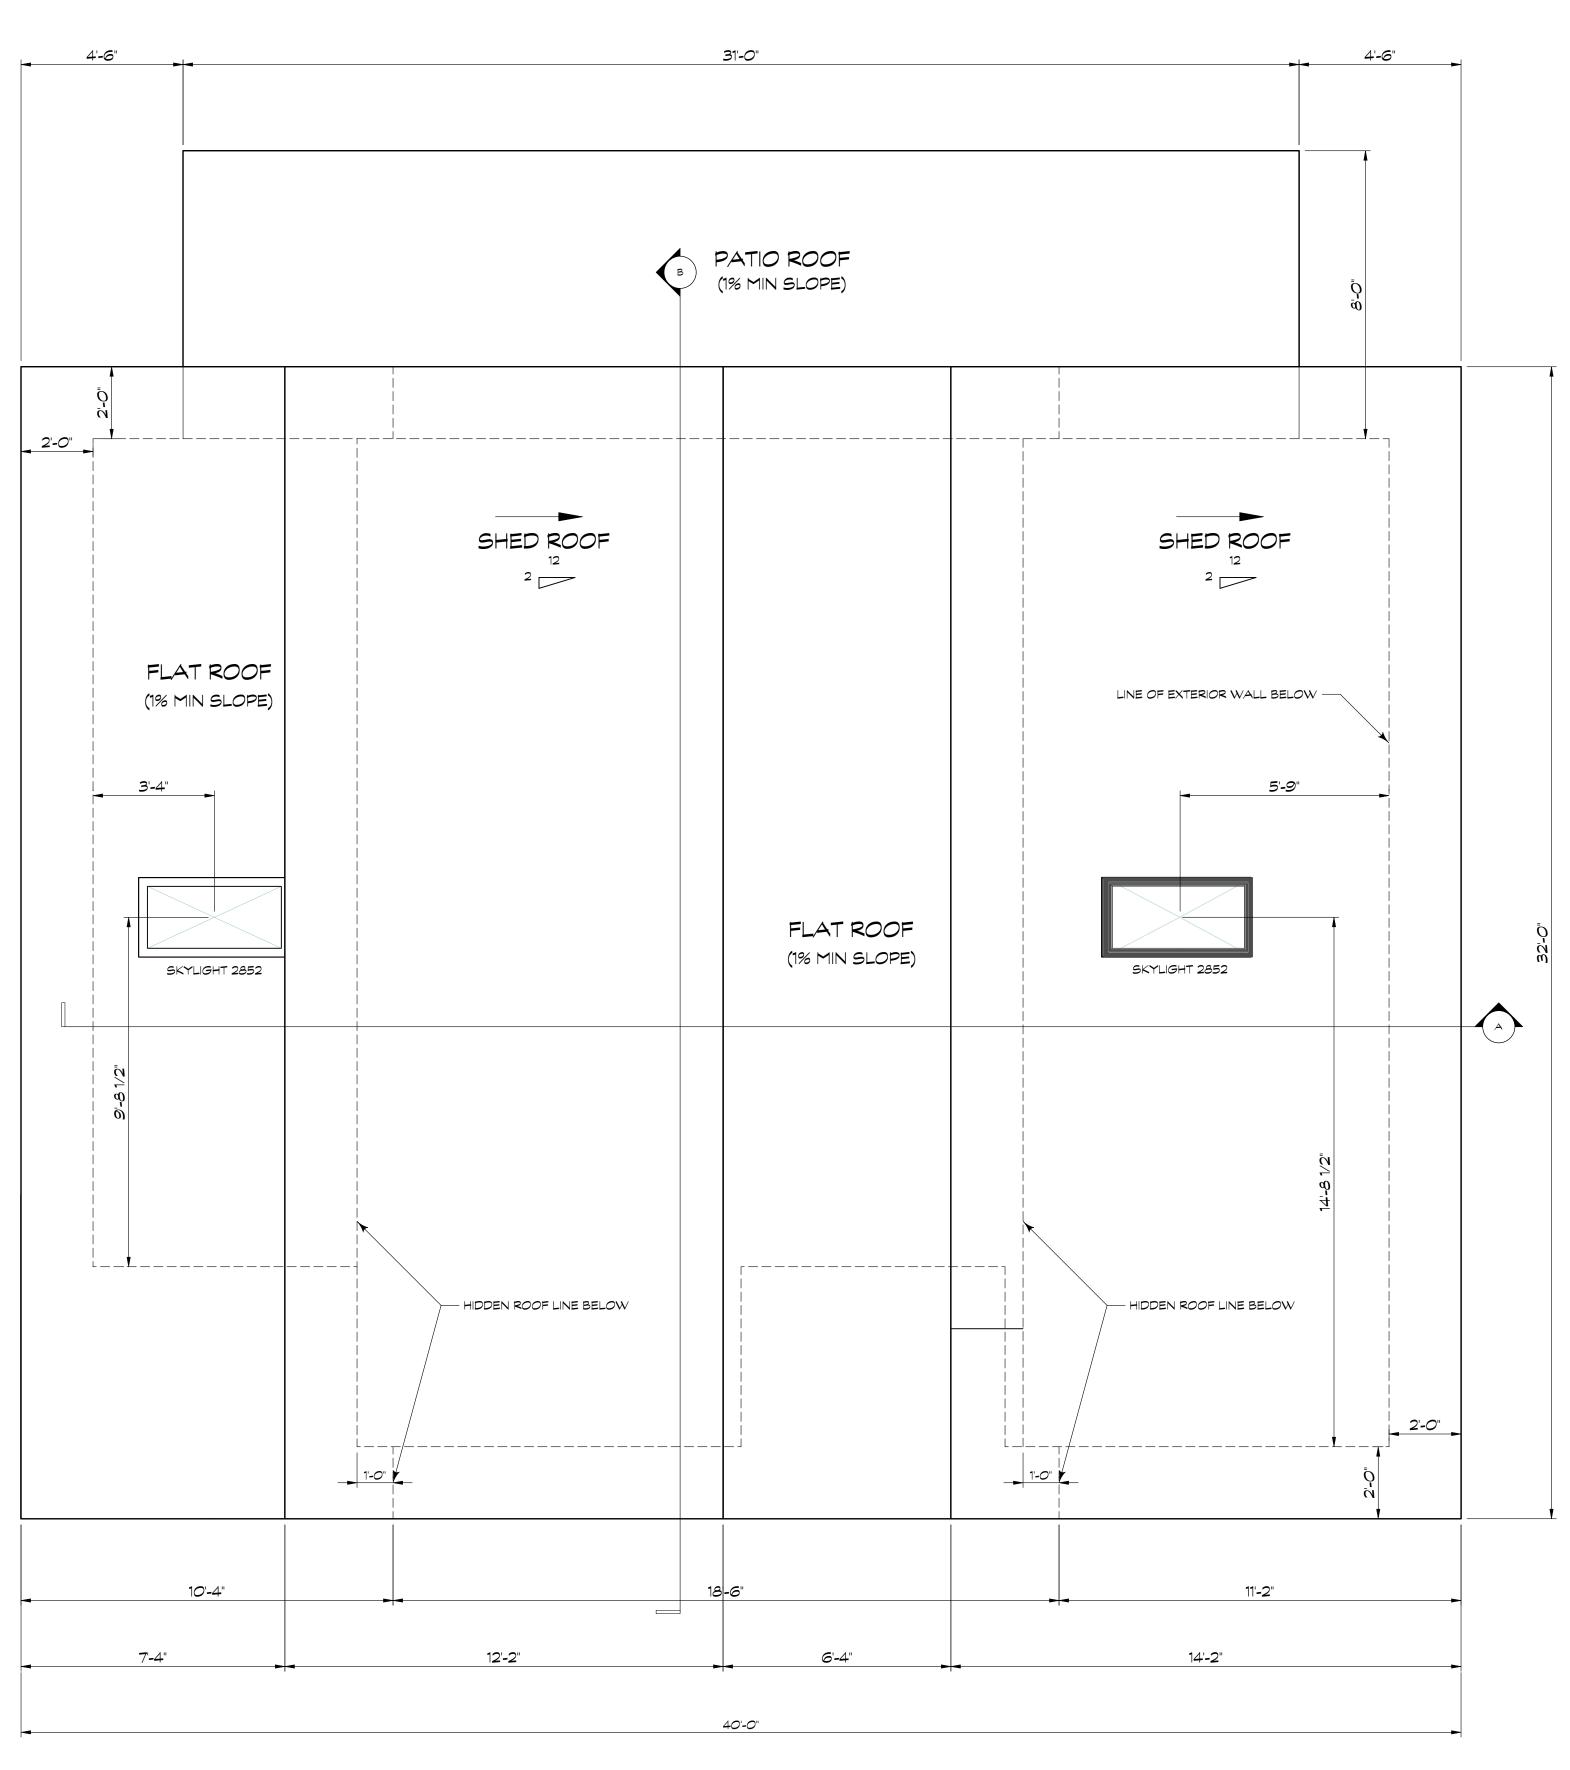



<u>ROOF PLAN</u> SCALE: 3/8" = 1'-0"

(1%) COVERED PATIO FLAT ROOF AREA =  $^248$  SQ FT (1%) FLAT ROOF AREA =  $^541$  SQ FT (9.5°) SHED ROOF AREA =  $^880$  SQ FT

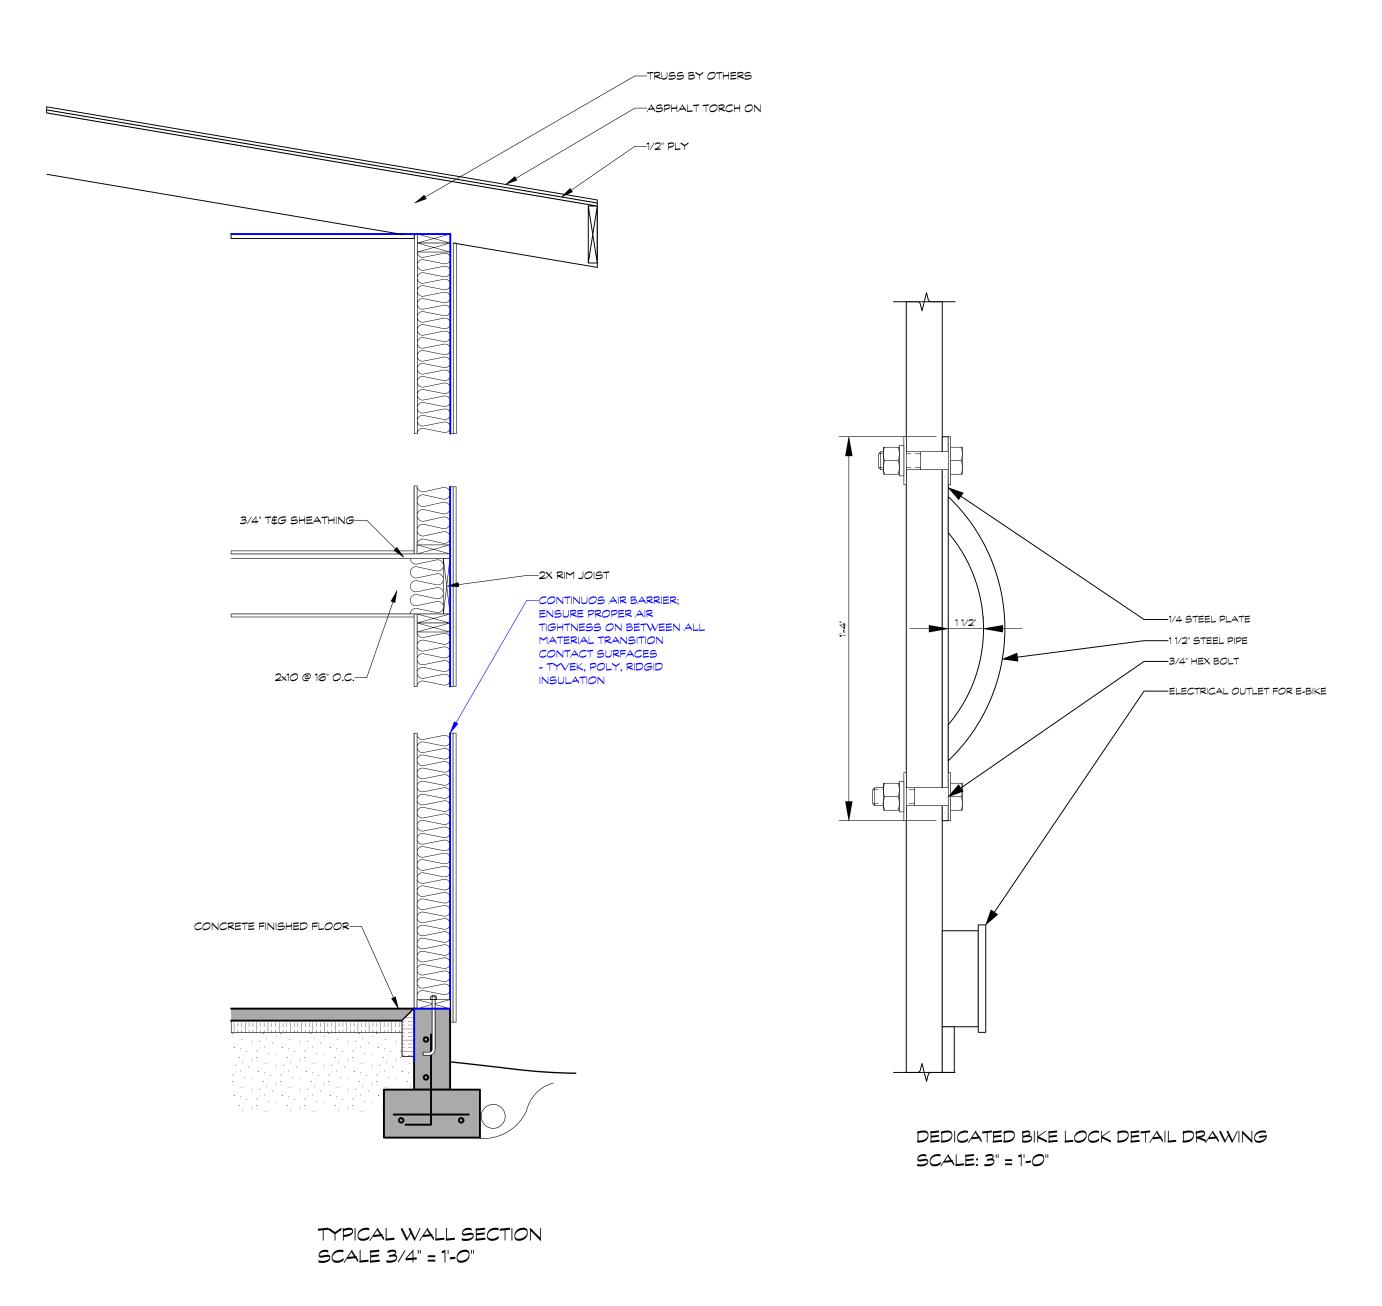

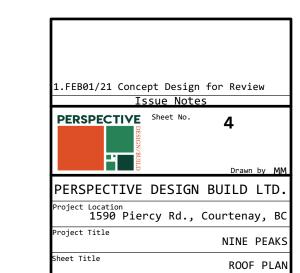

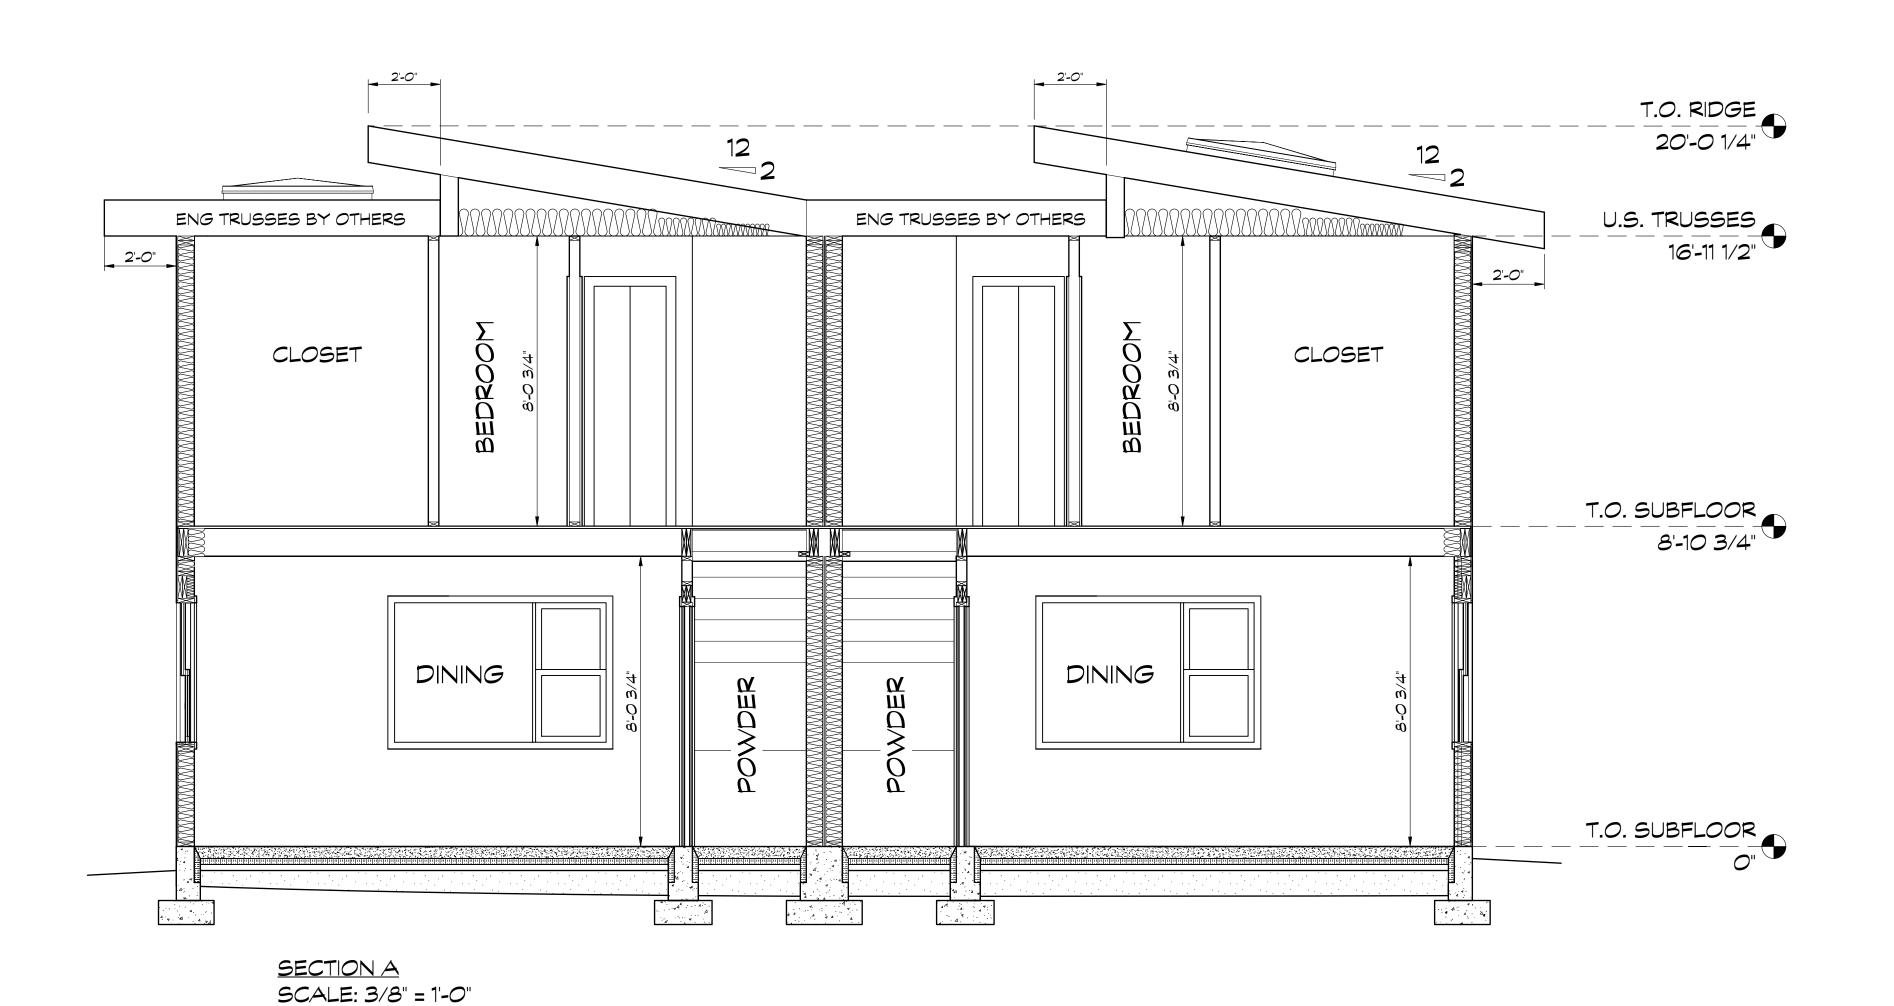

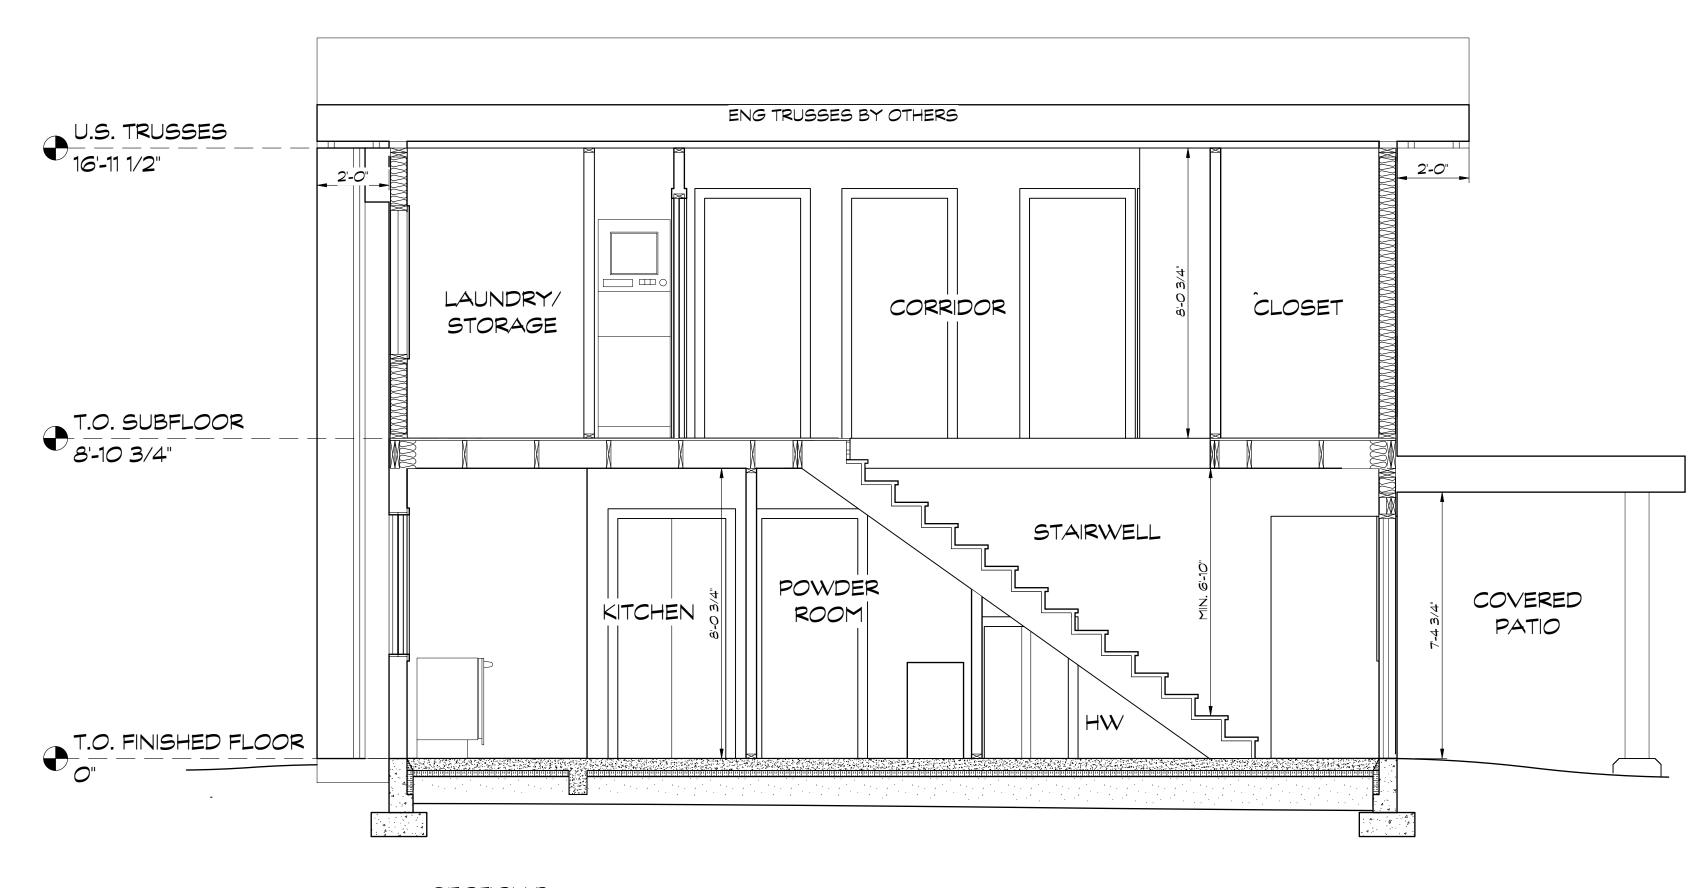

<u>SECTION B</u> SCALE: 3/8" = 1'-0"

VERSION FOR RE-ZONING PURPOSES

SEALED POLYETHYLENE AIR BARRIER - CODE REFERENCES 9.36.2.9. AIR TIGHTNESS 9.36.2.10. CONSTRUCTION OF AIR BARRIER DETAILS

ENSURE AIR BARRIER IS CONTINUOUS AND AIR TIGHT AT:

- PARTITION WALLS AT EXTERIOR WALLS AND CEILING
- RECESSED LIGHTS
- DRYER AND RANGE HOOD EXHAUSTS
- EXTERIOR DOOR AND WINDOW PENETRATIONS
- BATHROOM CEILING FANS
- PLUMBING PENETRATIONS
- MECHANICAL PENETRATIONS
- INTERIOR AND EXTERIOR ELECTRICAL PENETRATIONS
- RIM JOISTS
- FOUNDATION WALL TRANSITION





Front Elevation - Not to scale



Left Elevation - Not to scale



VERSION FOR RE-ZONING PURPOSES

1.FEB01/21 Concept Design for Review

Issue Notes


PERSPECTIVE Sheet No. 6

PERSPECTIVE DESIGN BUILD LTD.

Project Location
1590 Piercy Rd., Courtenay, BC

Project Title
NINE PEAKS

Sheet Title
ELEVATIONS

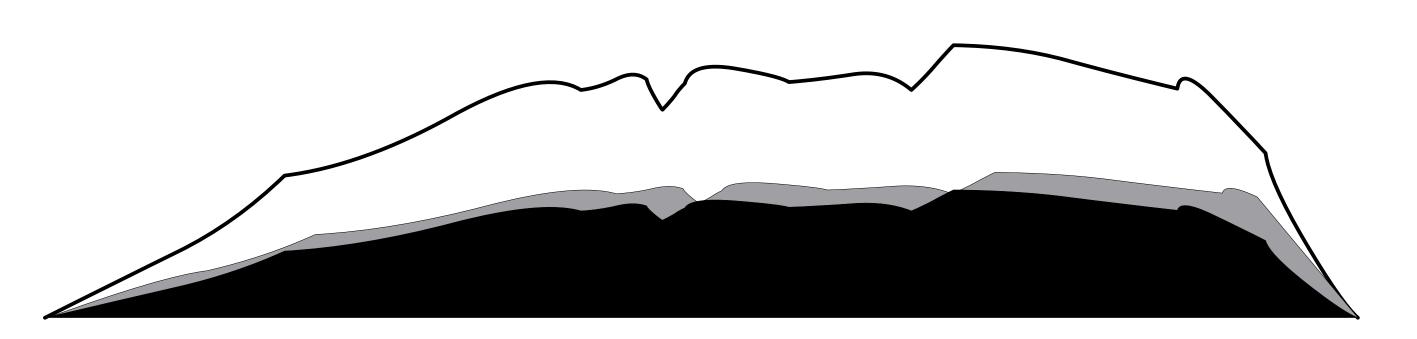

# NINE PEAKS

1590 PIERCY AVENUE, COURTENAY



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PERSPECTIVE DESIGN BUILD LTD.

1160 4TH ST., COURTENAY BRITISH COLUMBIA V9N 1H8

> **FOURPLEX DETAILED DESIGN**

TO SCALE ON 36X24 PRINT FORMAT ONLY

COVER SHEET REVISION

0.0

### COURTENAY DISTRICT, PLAN 4764 TOPOGRAPHIC SURVEY PLAN 1590 PIERCY AVENUE, COURTENAY SCALE 1: 150 (METRIC) PROJECT DATA R2 (TO BE RE-ZONED R3) ZONING

LOT AREA 0.5 ACRES (2030.5 SQ M) **ITEMS** PERMITTED PROPOSED


LOT COVERAGE /FAR 0.32 0.4 651.9 LOT COVERAGE TOTAL (SQ M) 812.2 HEIGHT (M) 6.1

#### SETBACKS (M)

FRONT	MIN 7.5	7.5
REAR	MIN 7.5	7.5
SIDE LEFT	MIN 1.5	3.3
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#### FLOOR AREAS

EXTERIOR	FLOOR	AREA	OF	2	DWEL	LINGS	BUILDING	(SQ M)	
EXTERIOR	FLOOR	AREA	OF	3	DWEL	LINGS	BUILDING	(SQ M)	
EXTERIOR	FLOOR	AREA	OF	4	DWEL	LINGS	BUILDING	(SQ M)	
EXTERIOR	FLOOR	AREA	IN	TO	JATC	(SQ M)	)		
(9)ENTRIE	ES IN	ΓΟΤΑL	(S(	1 9	۹)				

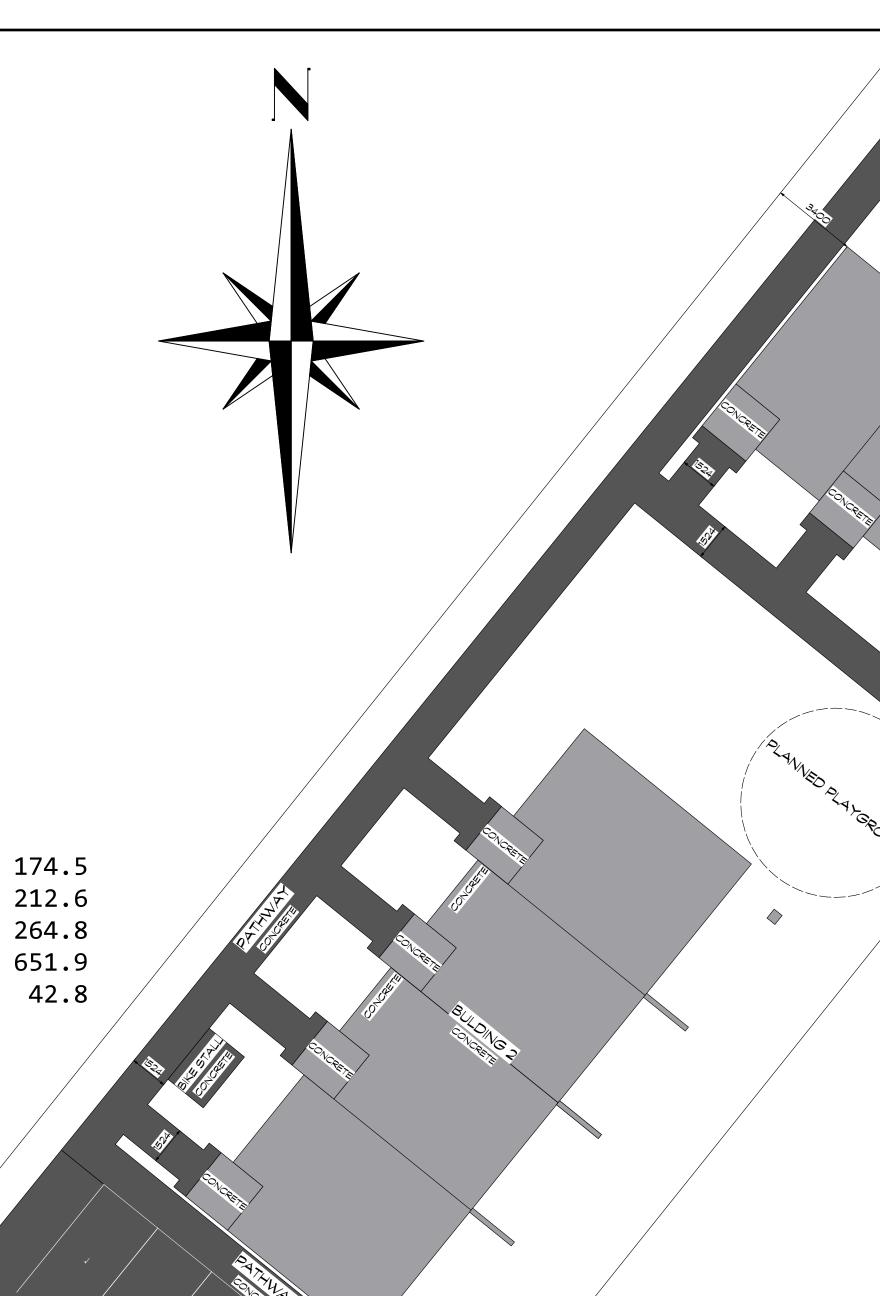

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FILE: 2211-80169-08



**PROPOSED** OFF-STREET PARKING REQUIRED SPACES (PER DWELLING INCL.10% VISITOR PARKING) 14 (1.5) 10 (1.1)

**BICYCLE PARKING ADDITION** LONG TERM PARKING SPACES SHORT TERM PARKING SPACES

OTHER PARKING LOT SPECIFICATIONS SHALL FOLLOW DIVISION 7, BYLAW 2500 (2007) REQUIRMENTS


SEE PARKING STUDY ISSUED AND SIGNED BY WATT CONSULTING GROUP, FILE NUMBER 2785.B01; MARCH 30, 2020


#### SITEPLAN NOTES


TYPICAL PARKING SPACE LAYOUT

NO SCALE

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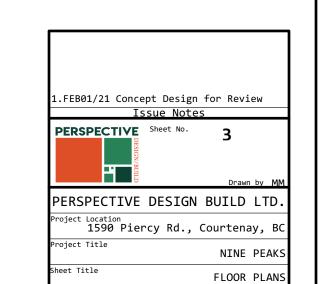


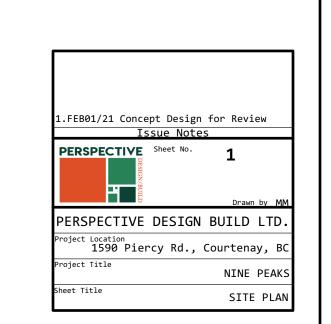


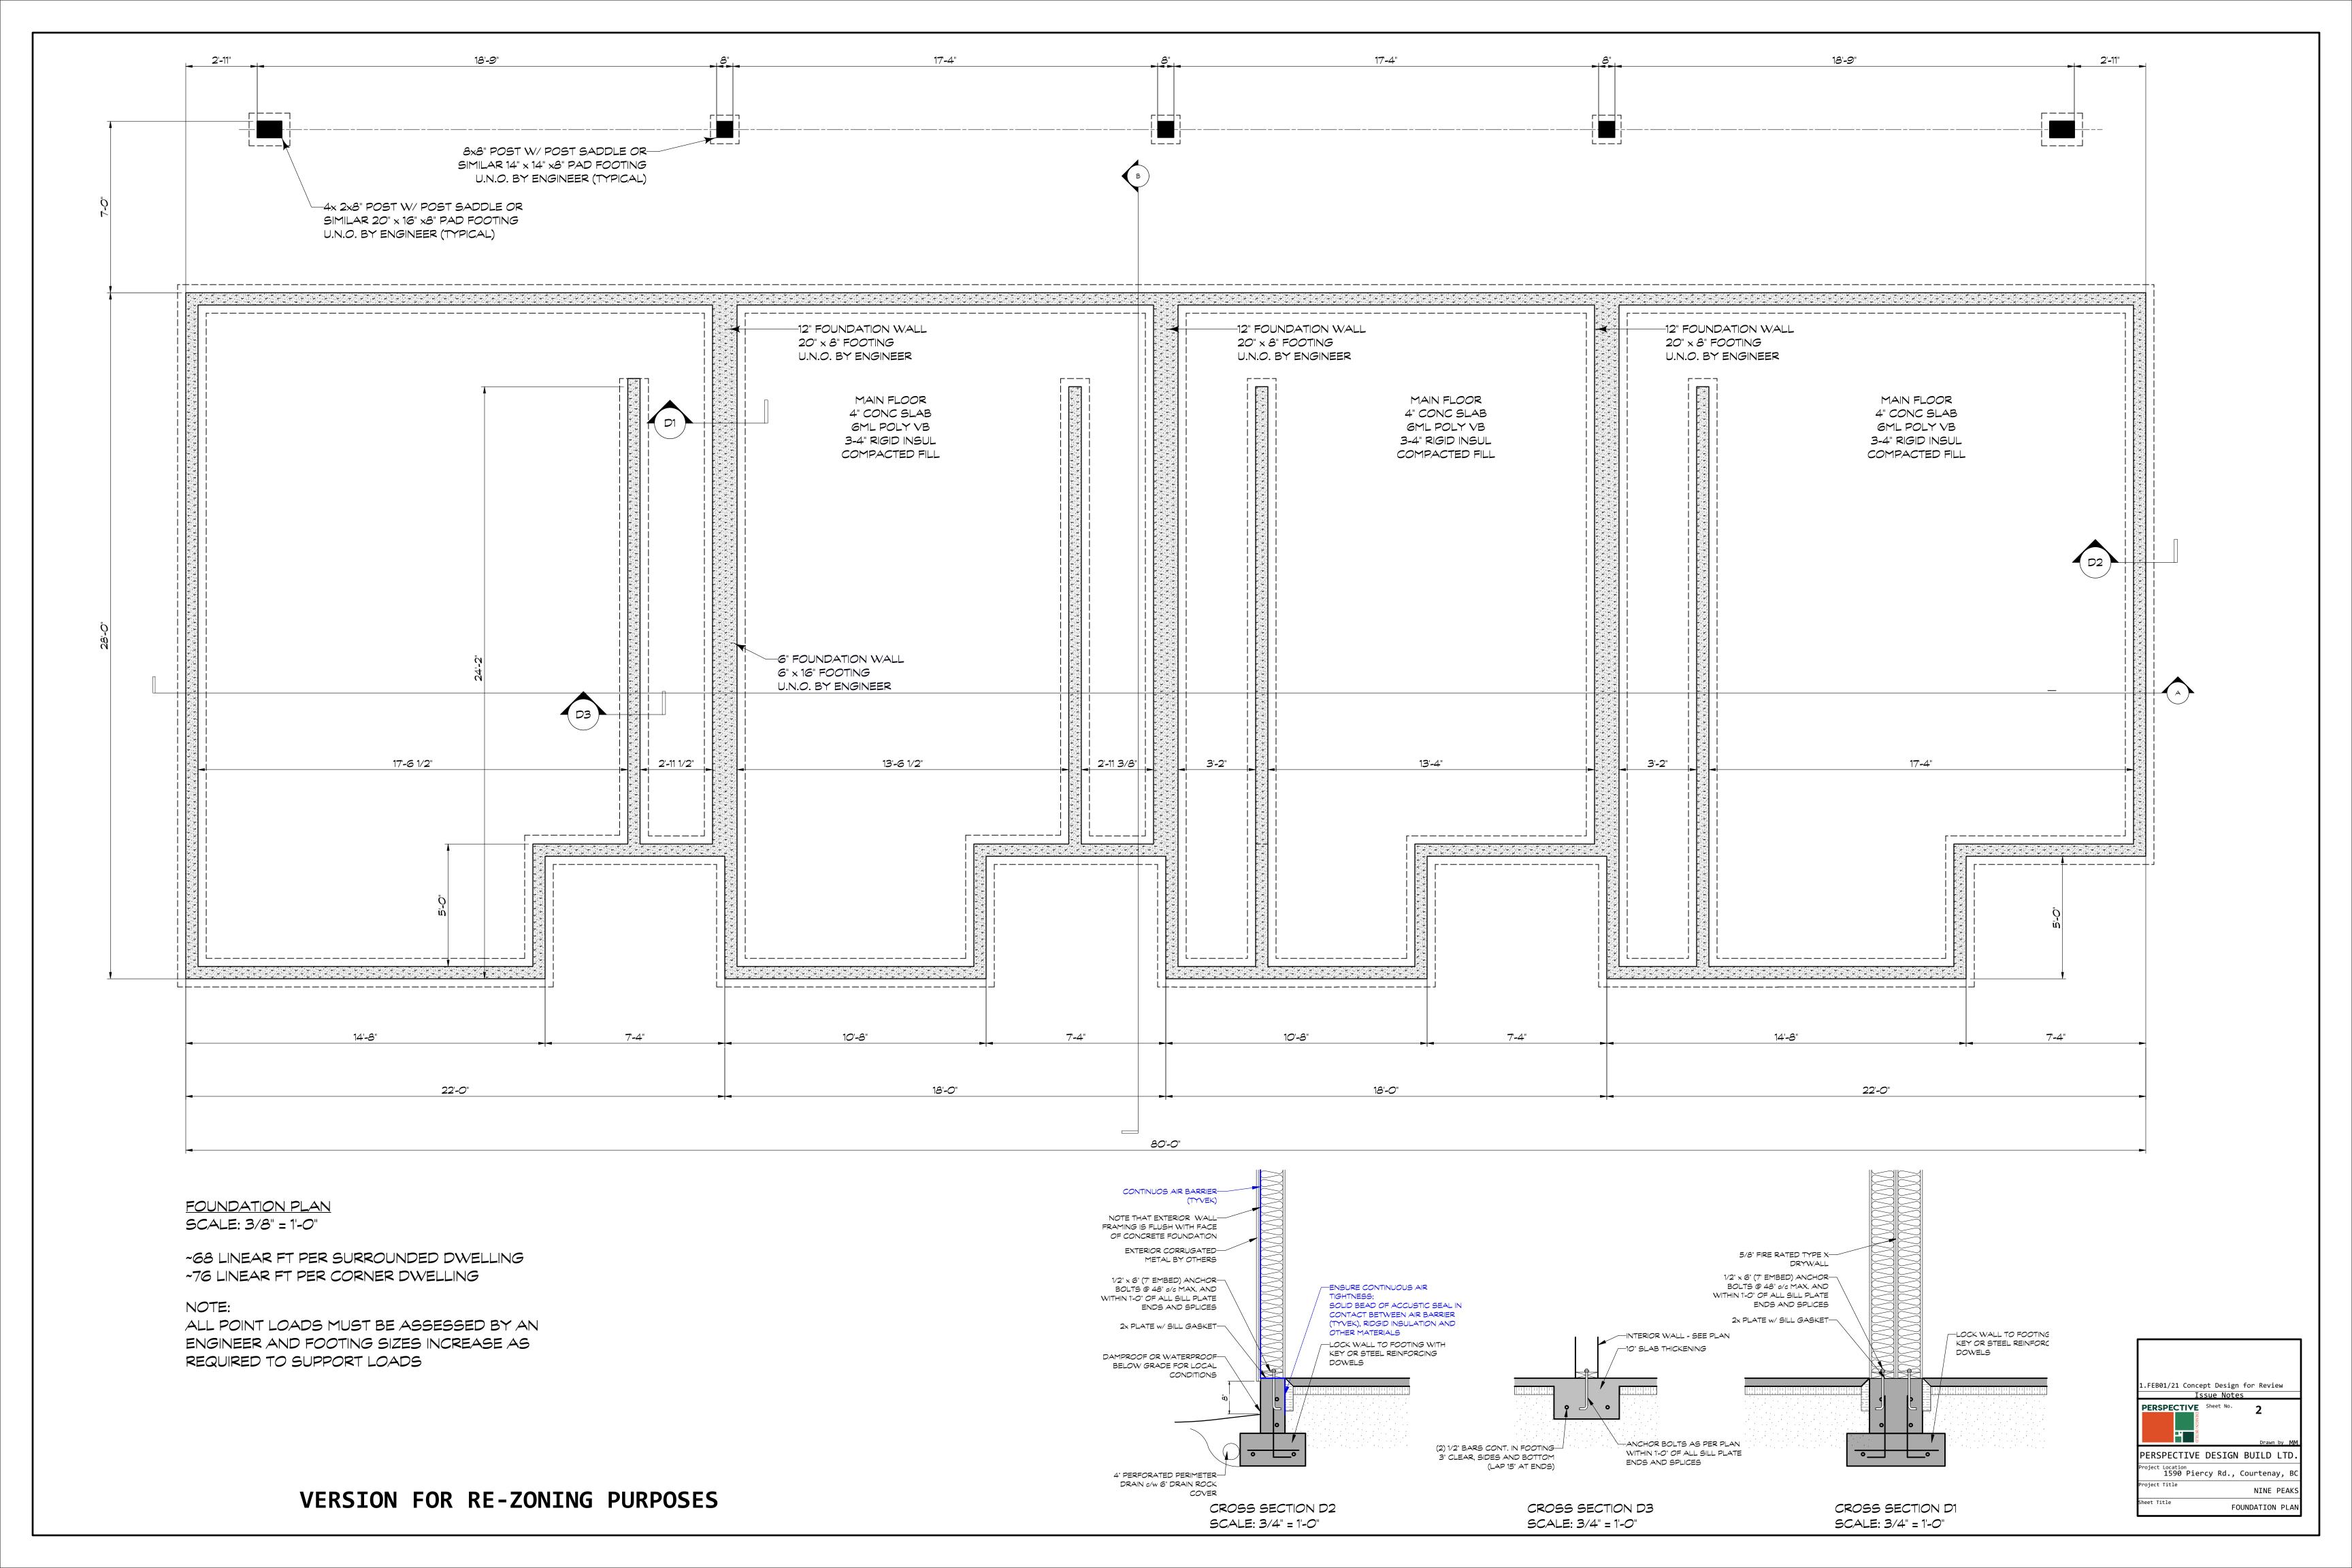MAIN FLOOR PLAN SCALE: 3/8" = 1'-0"

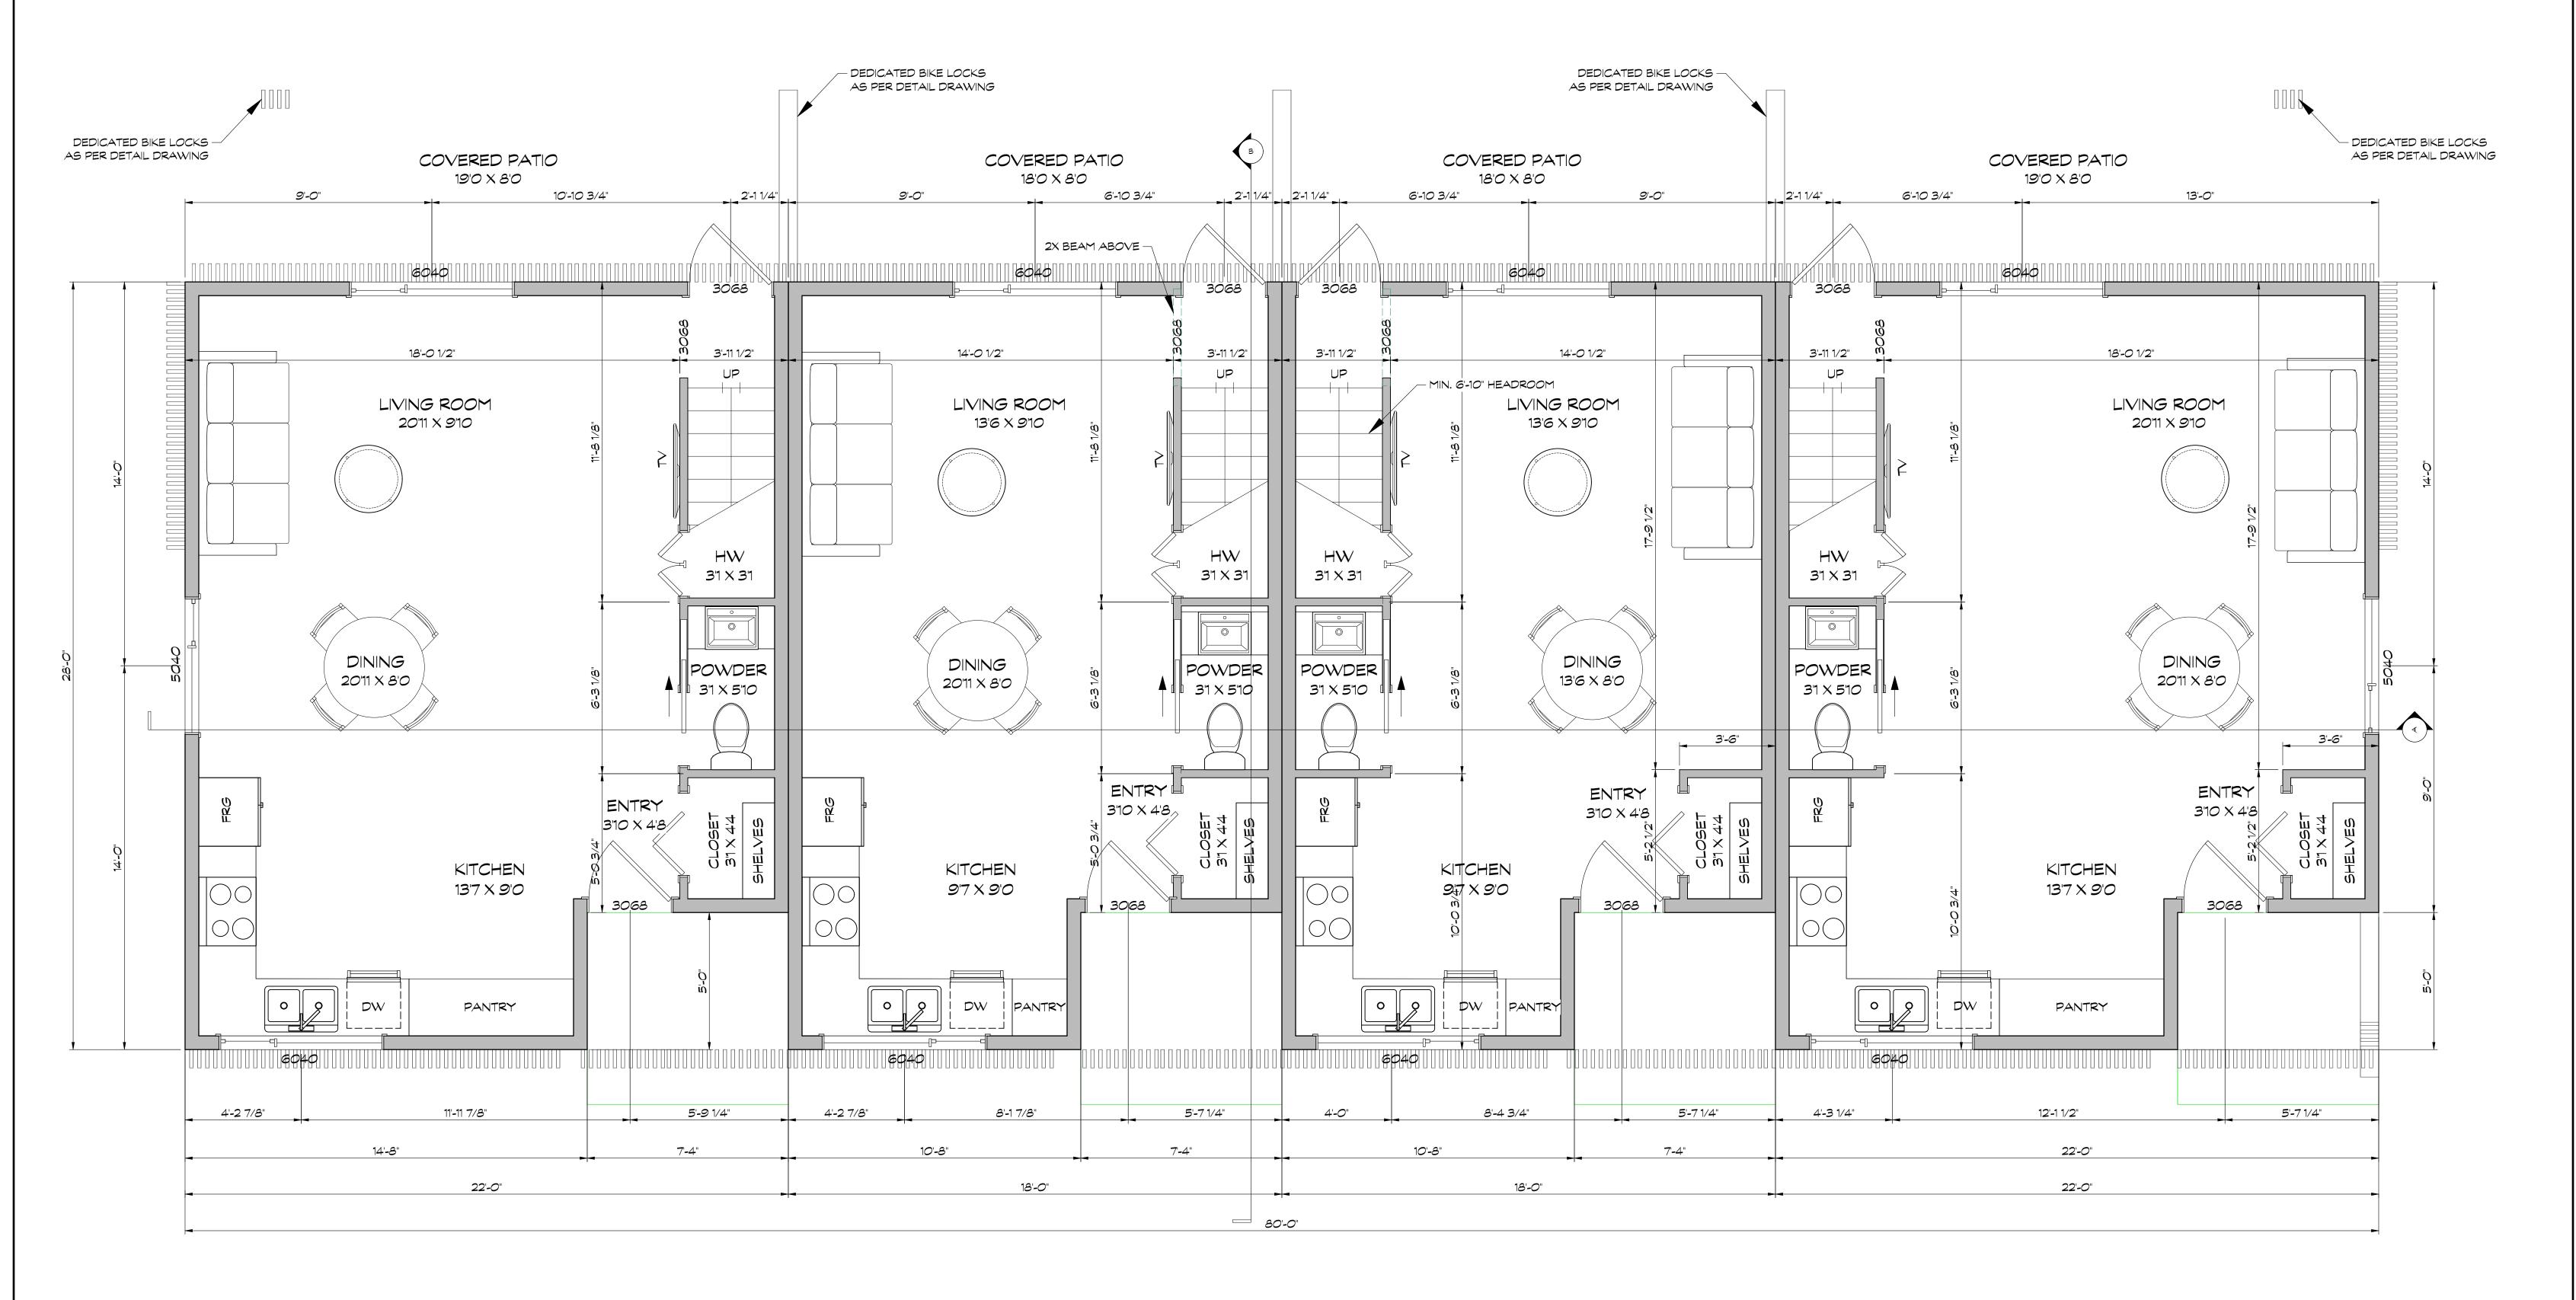467 SQ FT (EXTERIOR FLOOR AREA PER 2BDRM DWELLING) 580 SQ FT (EXTERIOR FLOOR AREA PER 3BDRM DWELLING) 51 SQ FT (ENTRY SLAB PER DWELLING)

2094 SQ FT (EXTERIOR FLOOR AREA IN TOTAL PER BUILDING) 204 SQ FT (ENTRY SLABS IN TOTAL PER BUILDING)




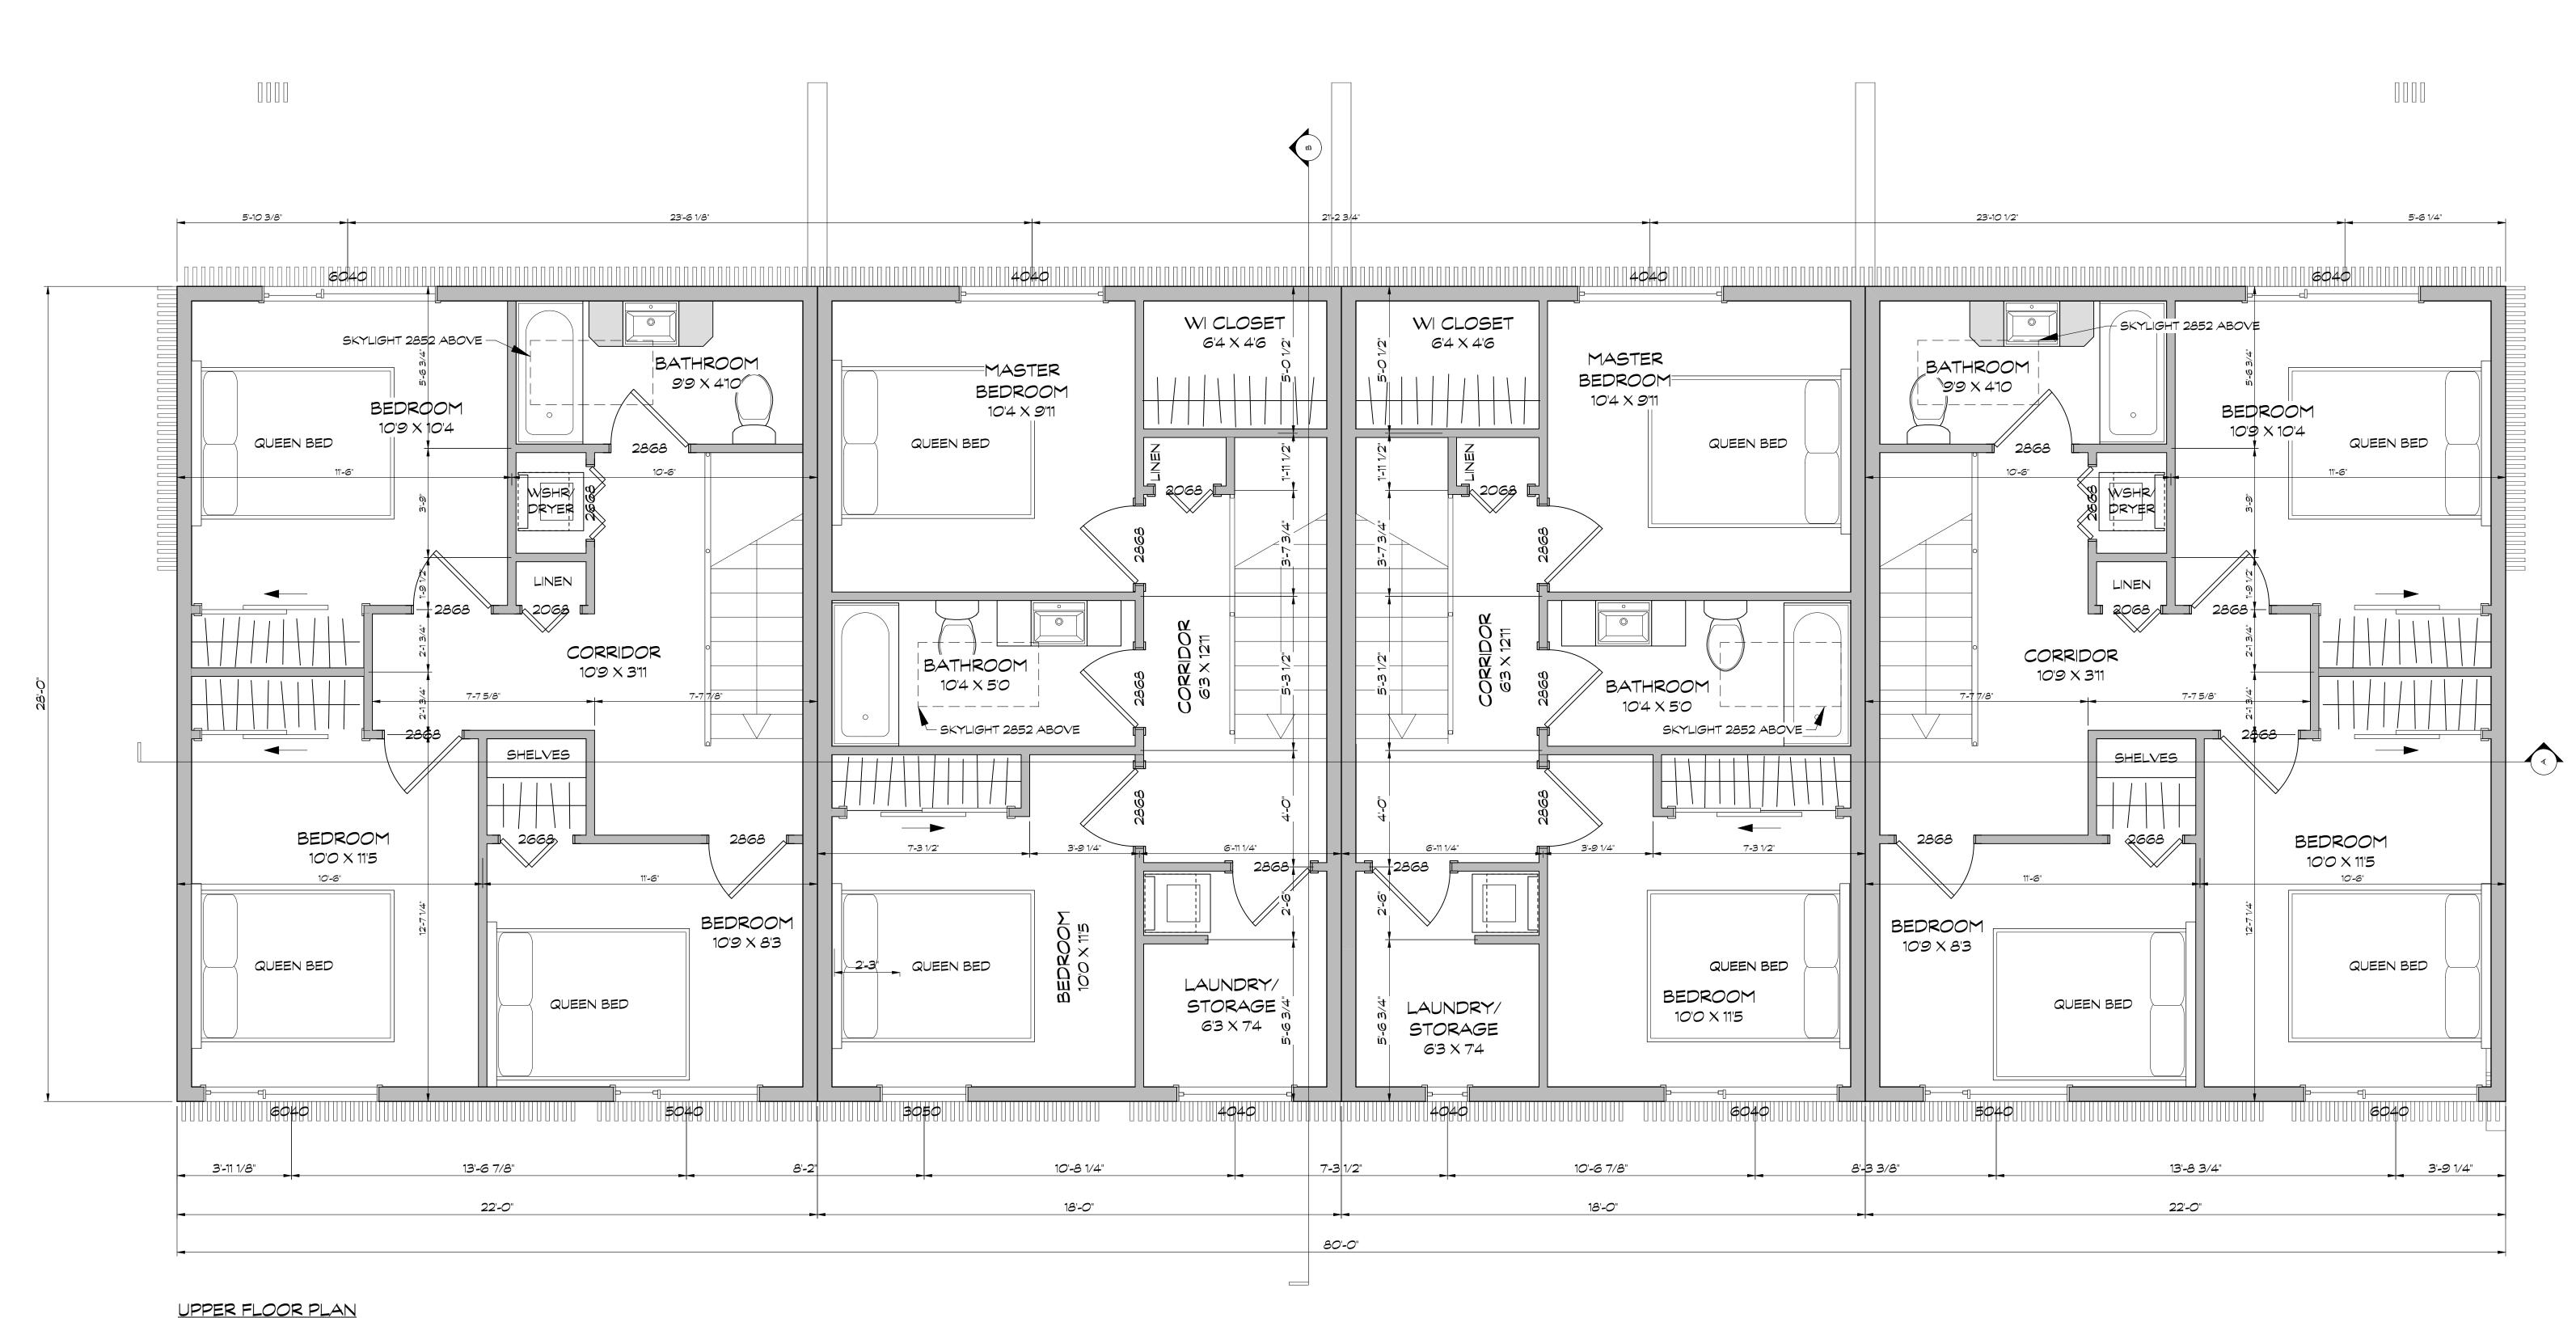


<u>UPPER FLOOR PLAN</u> SCALE: 3/8" = 1'-0"

472 SQ FT (EXTERIOR FLOOR AREA IN PER 2BDRM DWELLING) 616 SQ FT (EXTERIOR FLOOR AREA IN PER 3BDRM DWELLING)


2176 SQ FT (EXTERIOR FLOOR AREA IN TOTAL PER BUILDING)

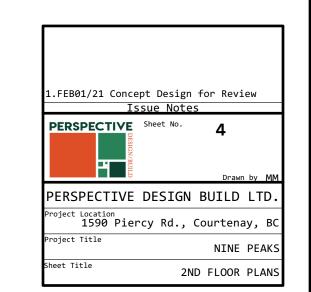


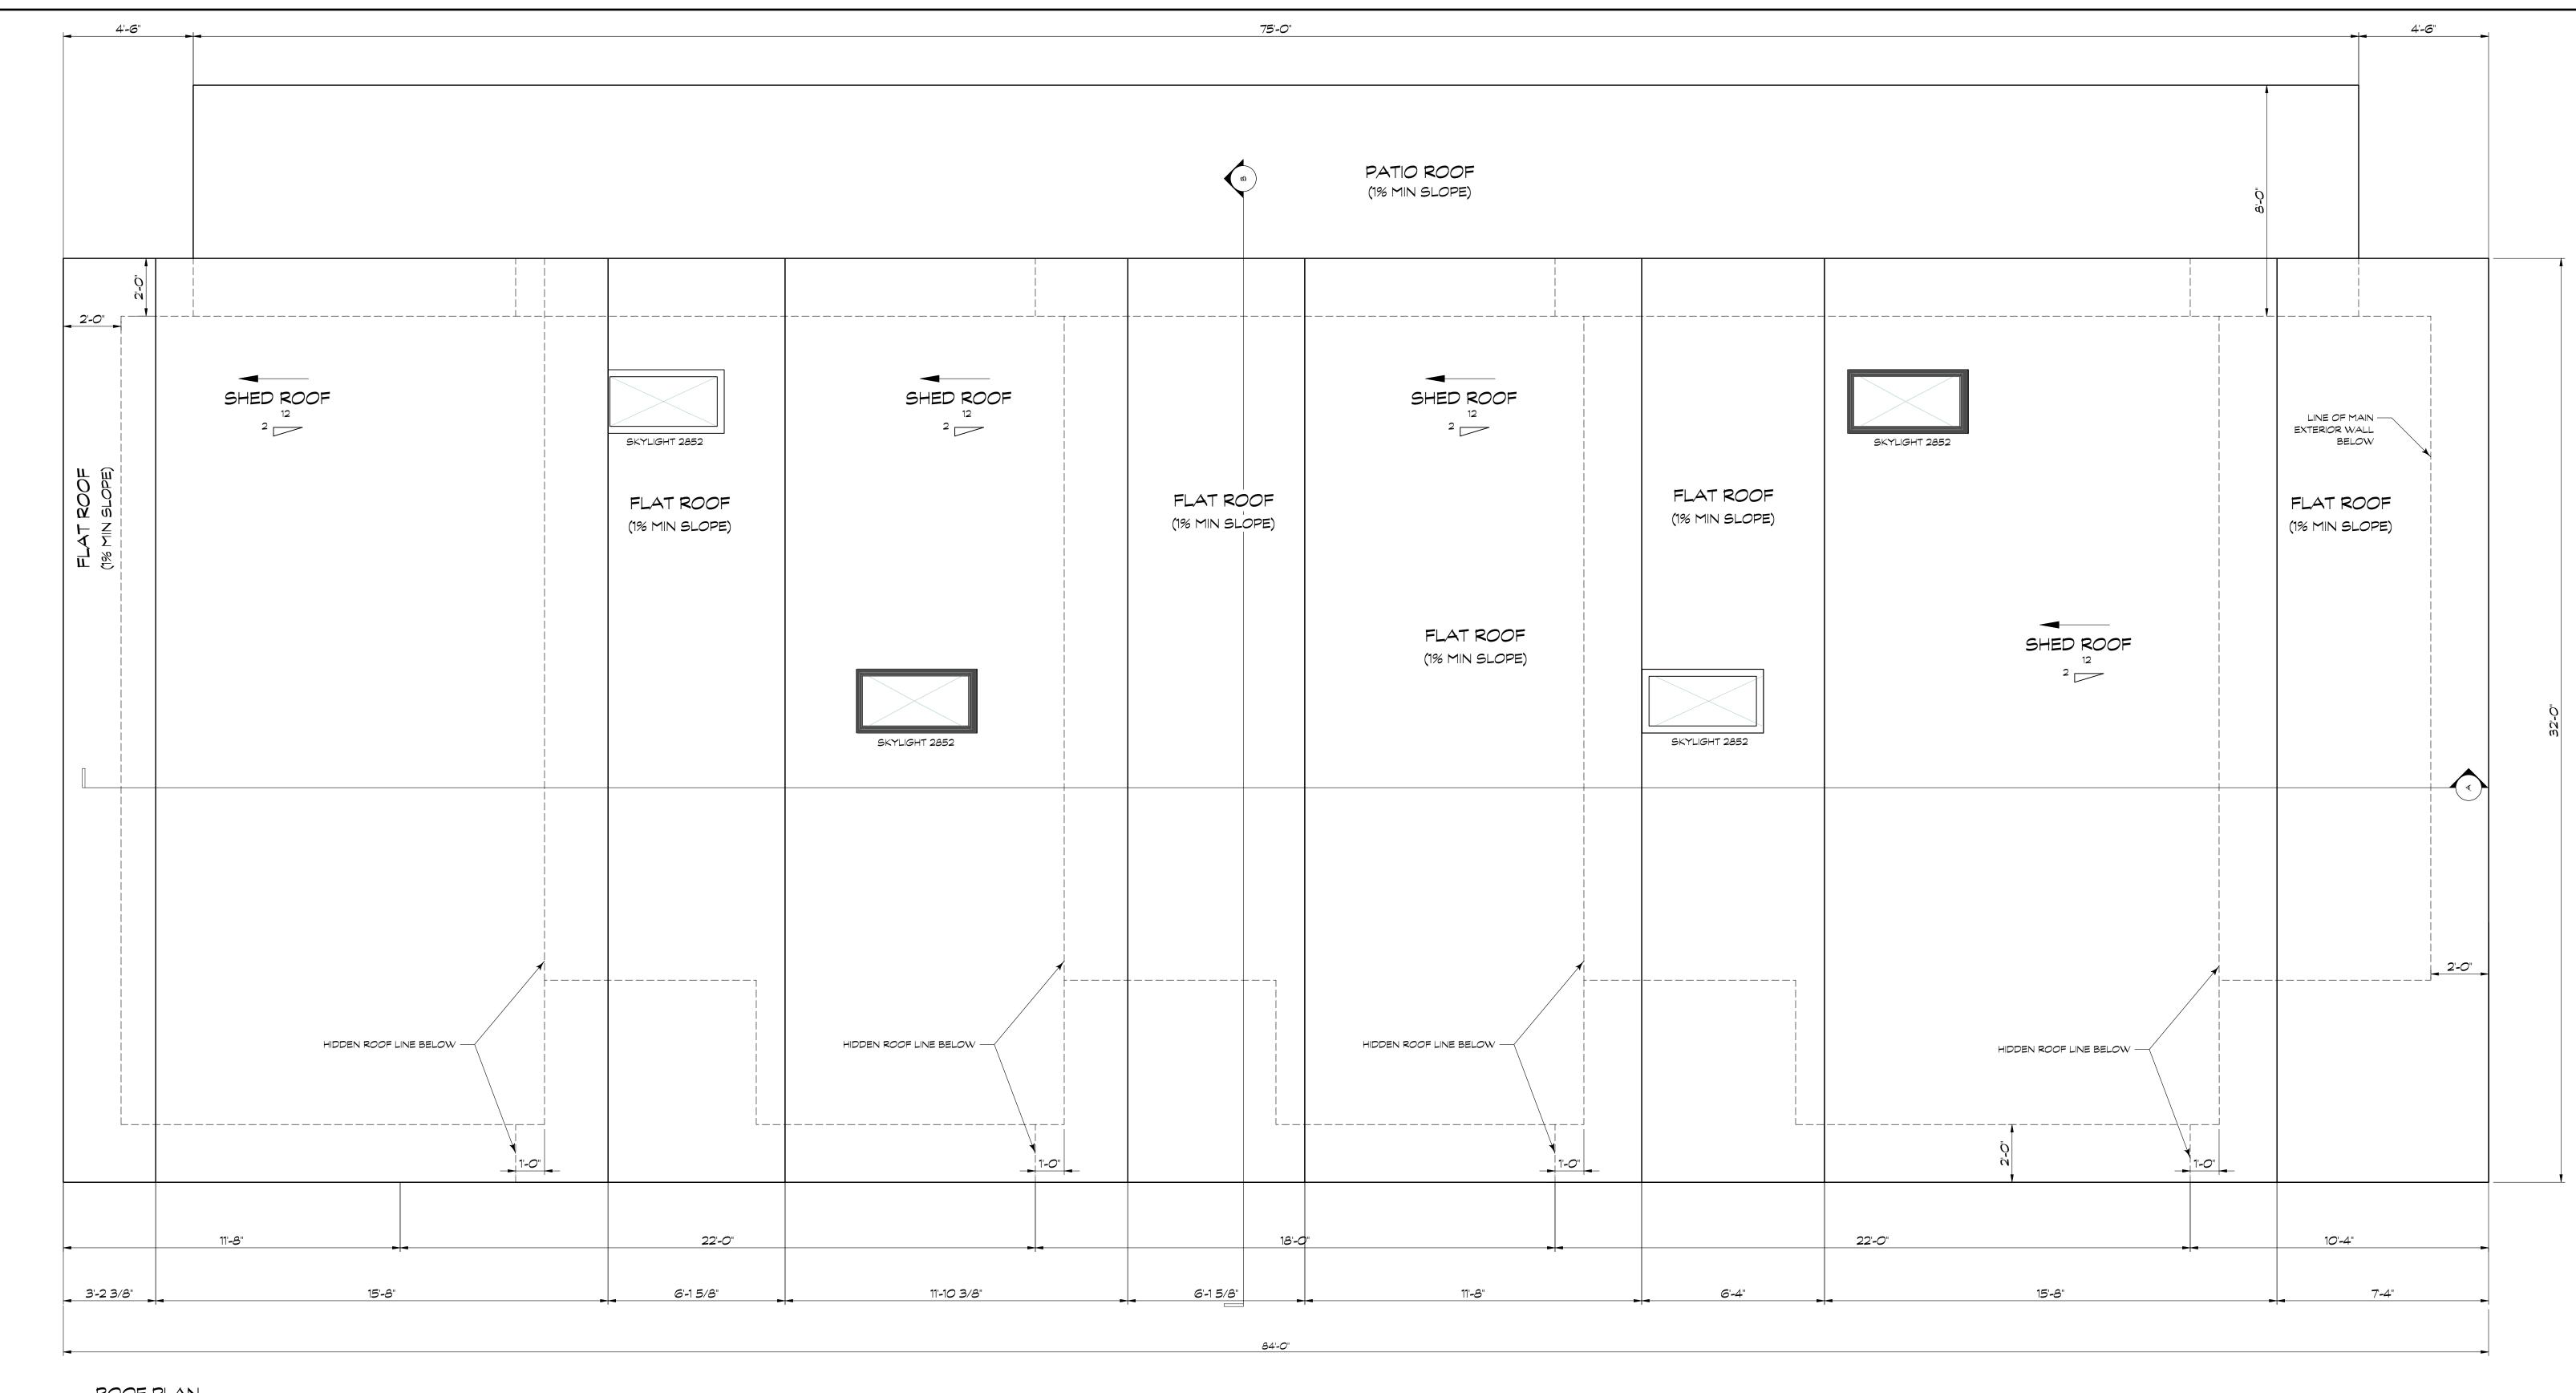

<u>ROOF PLAN</u> SCALE: 3/8" = 1'-0"

(1%) COVERED PATIO FLAT ROOF AREA =  $\sim$ 600 SQ FT (1%) FLAT ROOF AREA =  $\sim$ 1310 SQ FT (9.5°) SHED ROOF AREA =  $\sim$ 1569 SQ FT

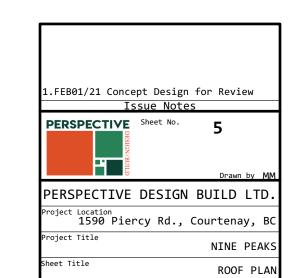

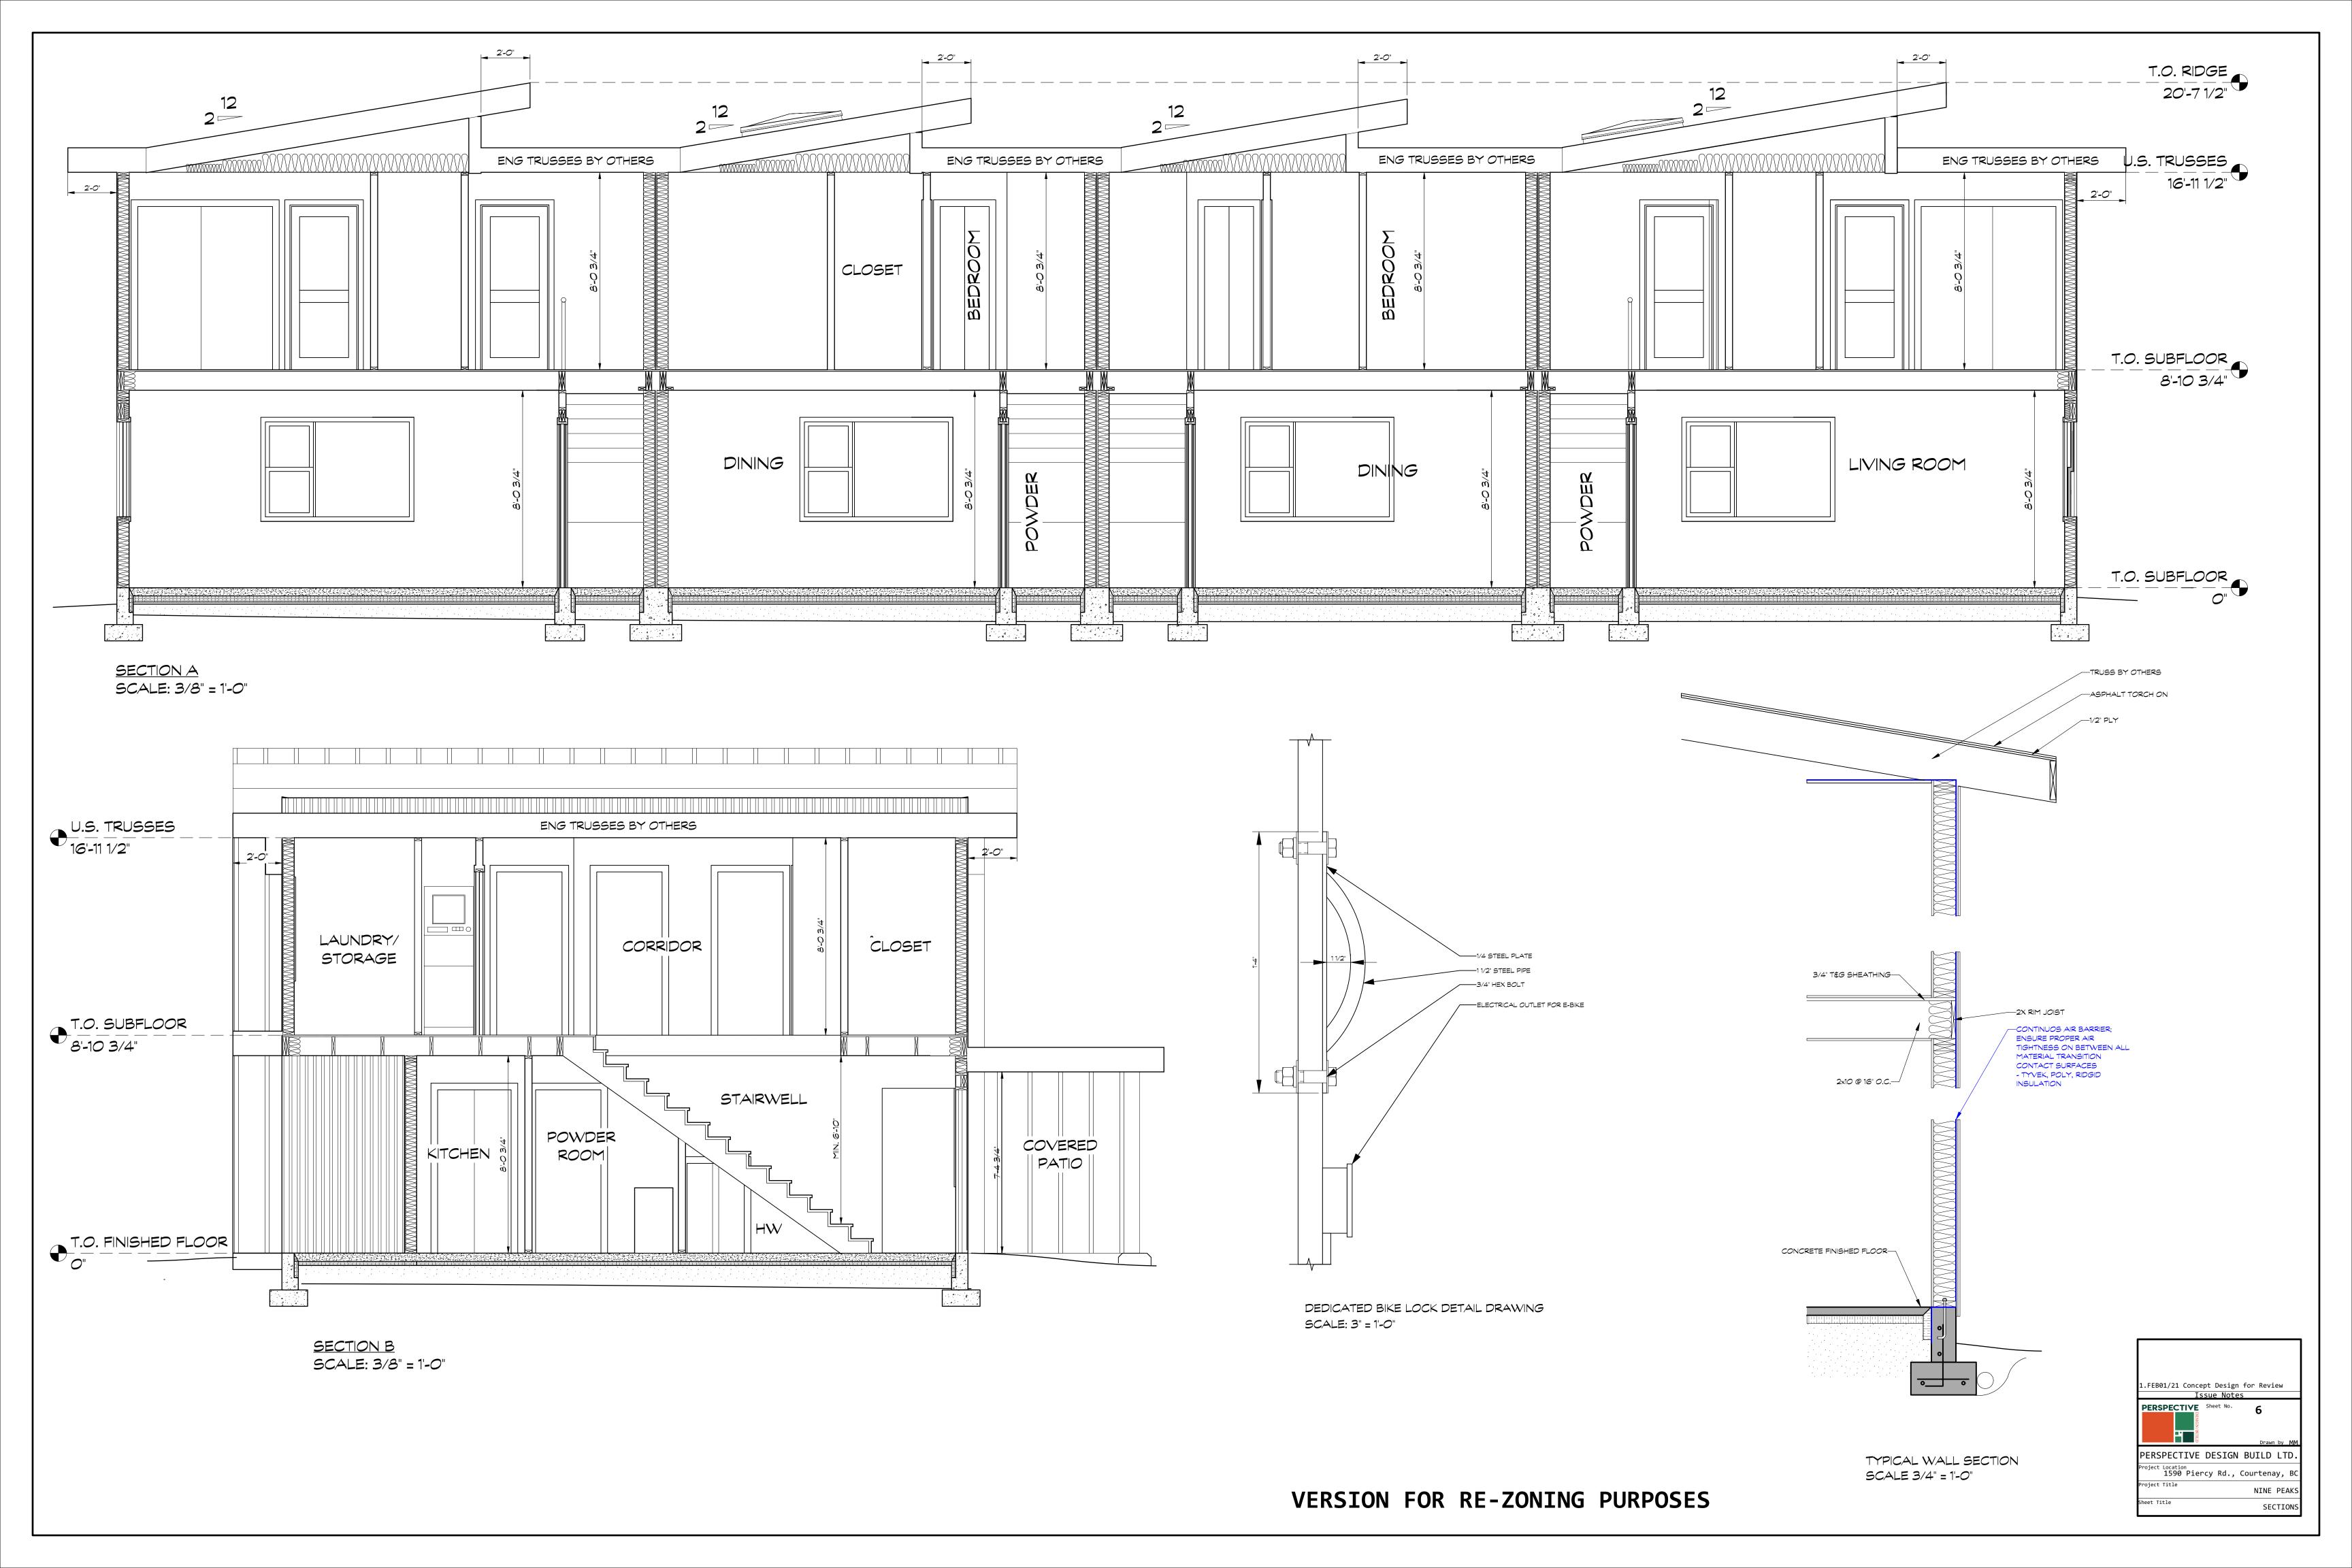



Rear Elevation- Not to scale




Right Elevation - Not to scale





Left Elevation - Not to scale



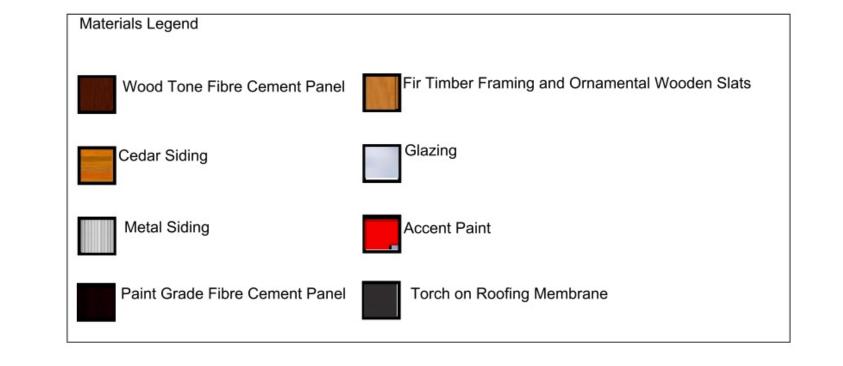

Front Elevation - Not to scale

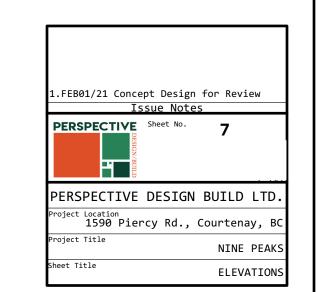

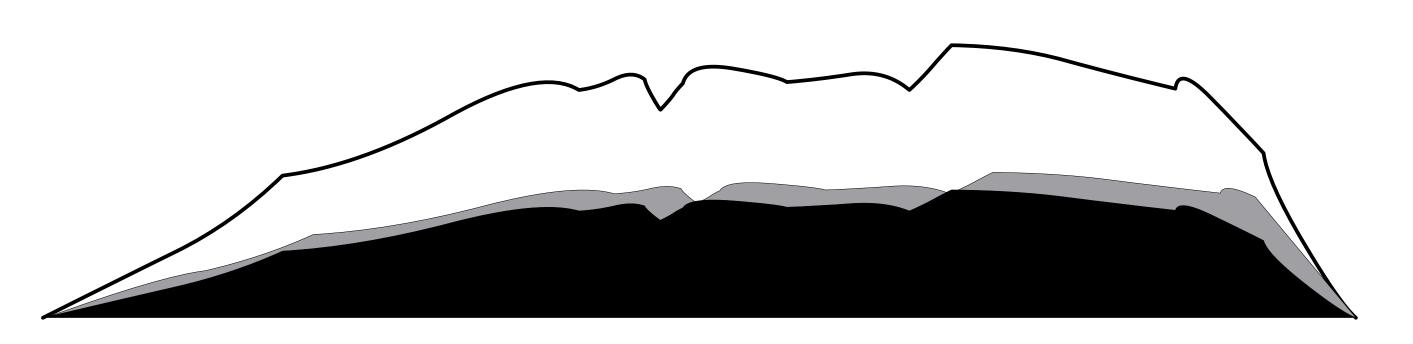

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1590 PIERCY AVENUE, COURTENAY



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1160 4TH ST., COURTENAY BRITISH COLUMBIA V9N 1H8

TRIPLEX
DETAILED DESIGN

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COVER SHEET 0.0 REVISION July 20, 2021

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FRONT	MIN 7.5	7.5
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#### FLOOR AREAS

EXTERIOR FLOOR AREA OF 2 DWELLINGS	BUILDING (SQ M)
EXTERIOR FLOOR AREA OF 3 DWELLINGS	BUILDING (SQ M)
EXTERIOR FLOOR AREA OF 4 DWELLINGS	BUILDING (SQ M)
EXTERIOR FLOOR AREA IN TOTAL (SQ M)	
(9)ENTRIES IN TOTAL (SQ M)	

174.5

212.6

264.8

651.9


42.8

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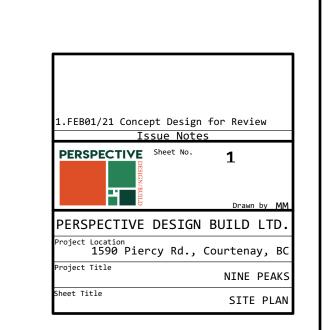
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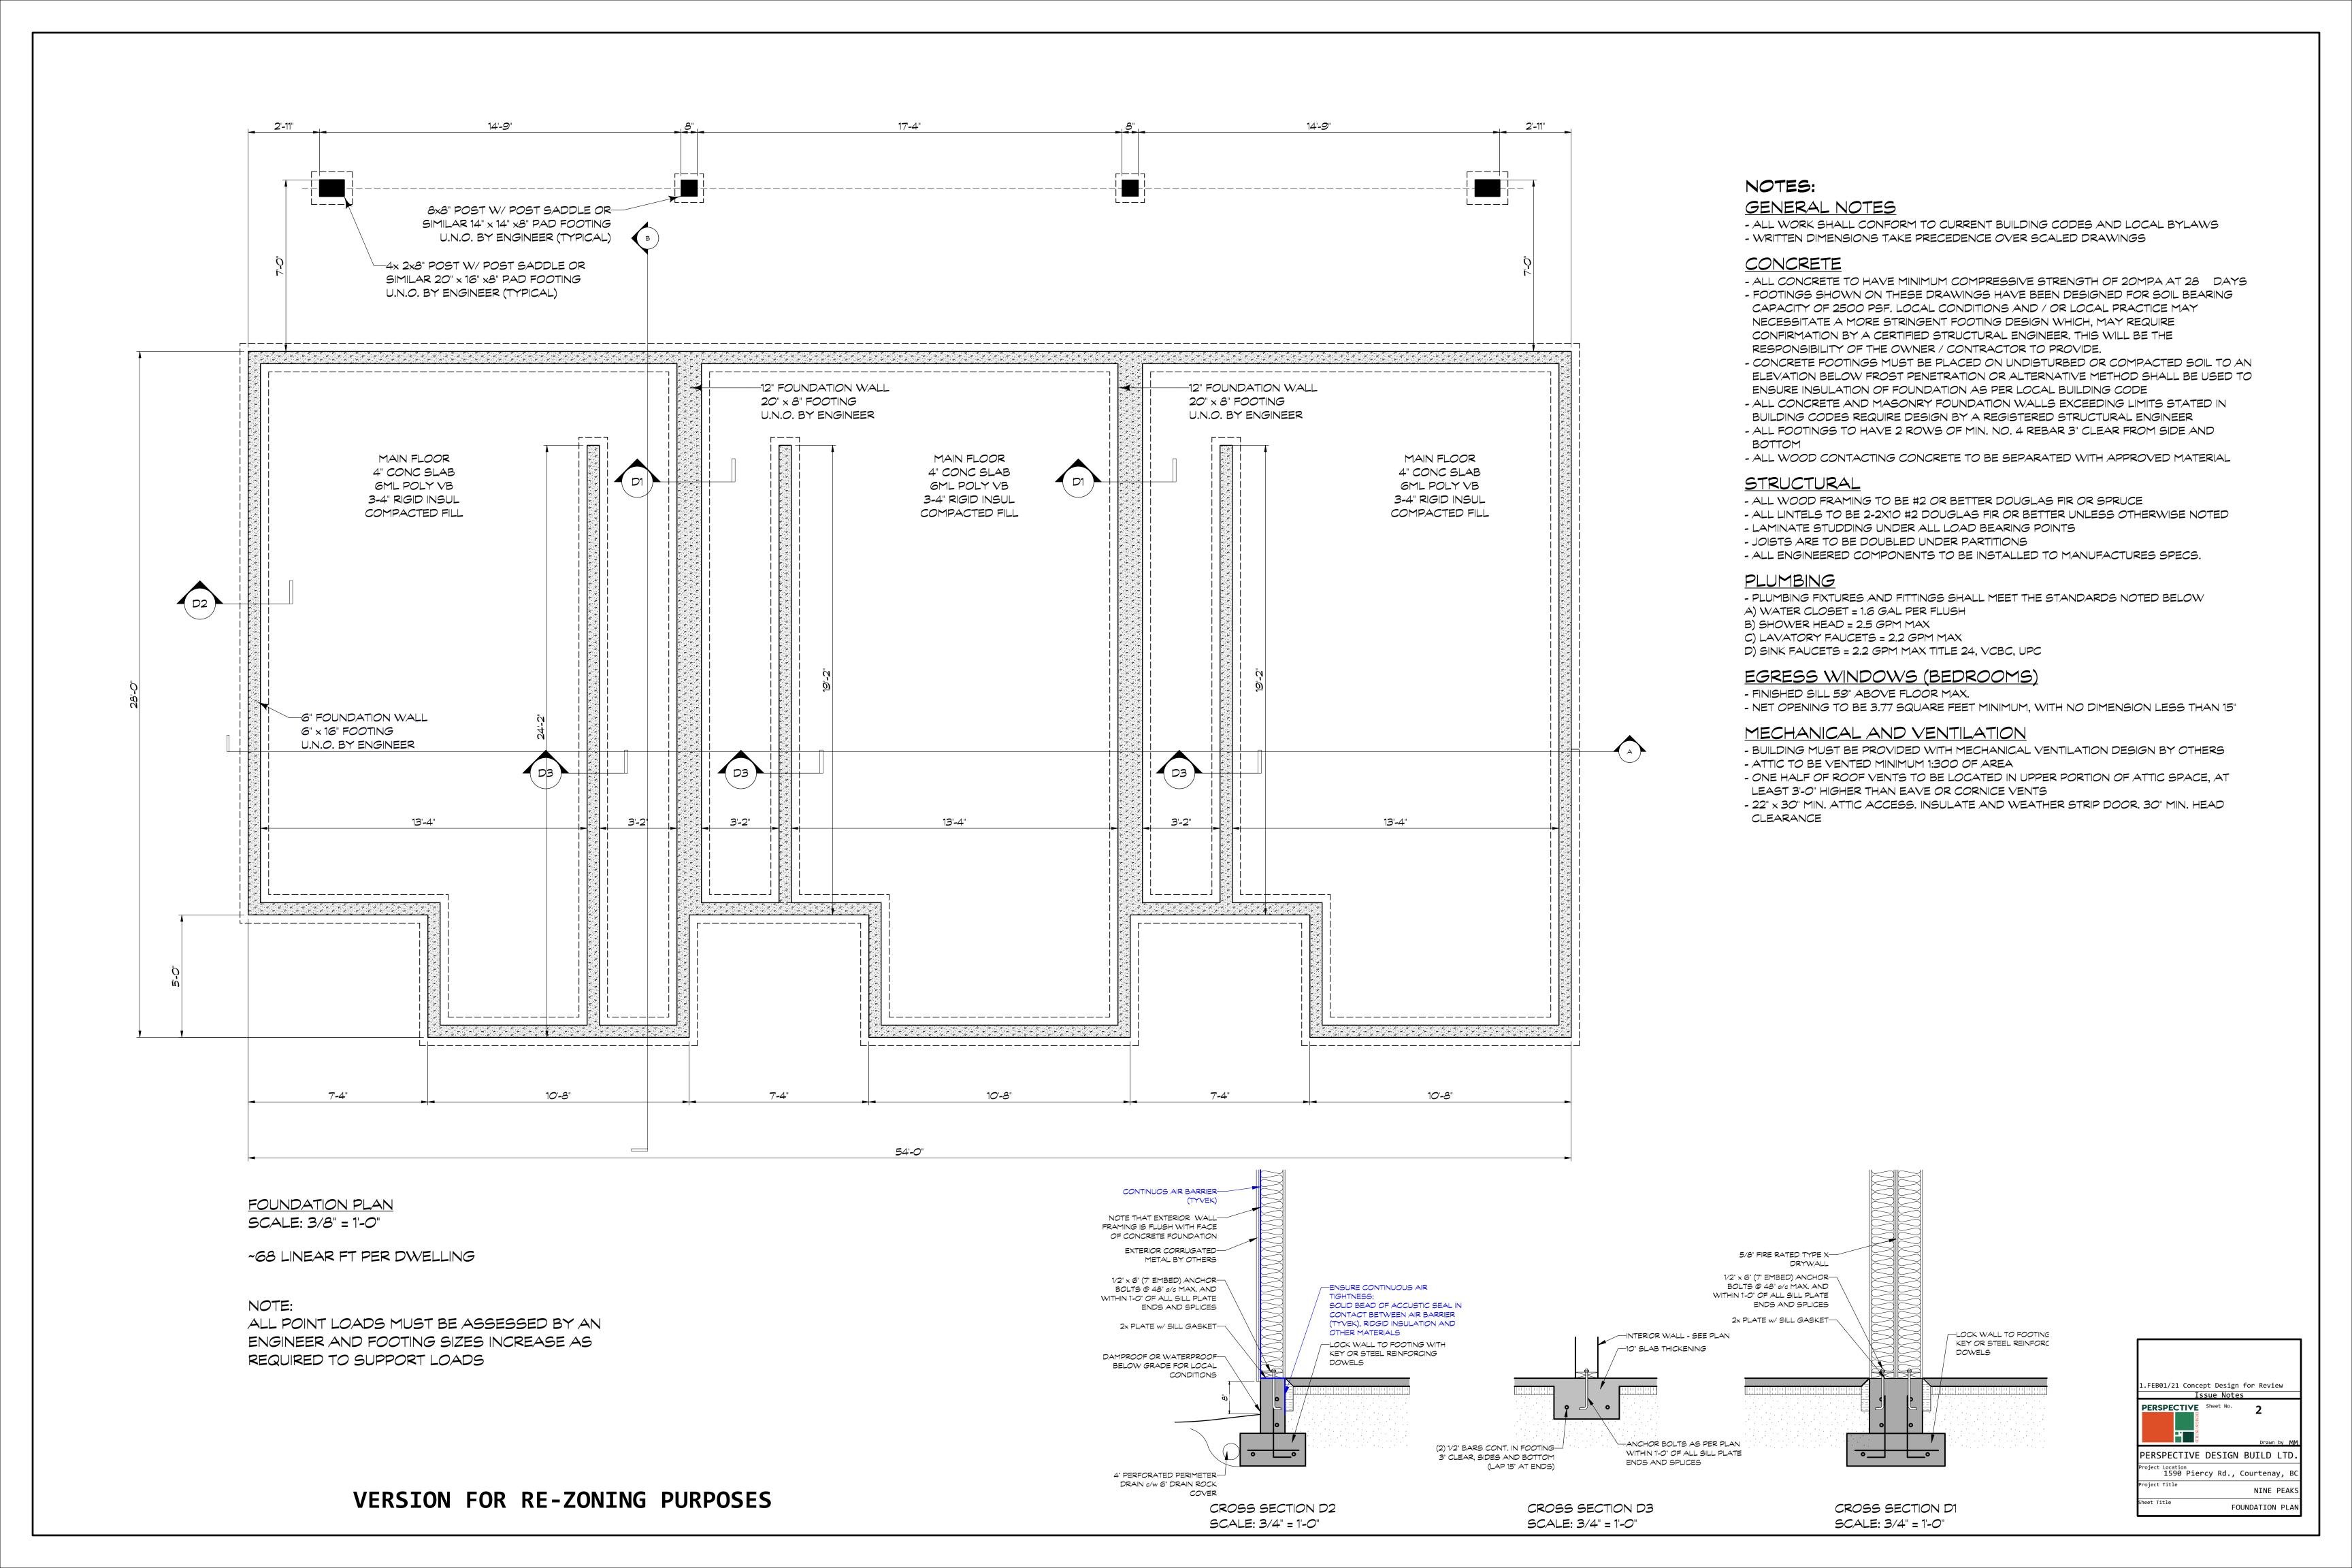
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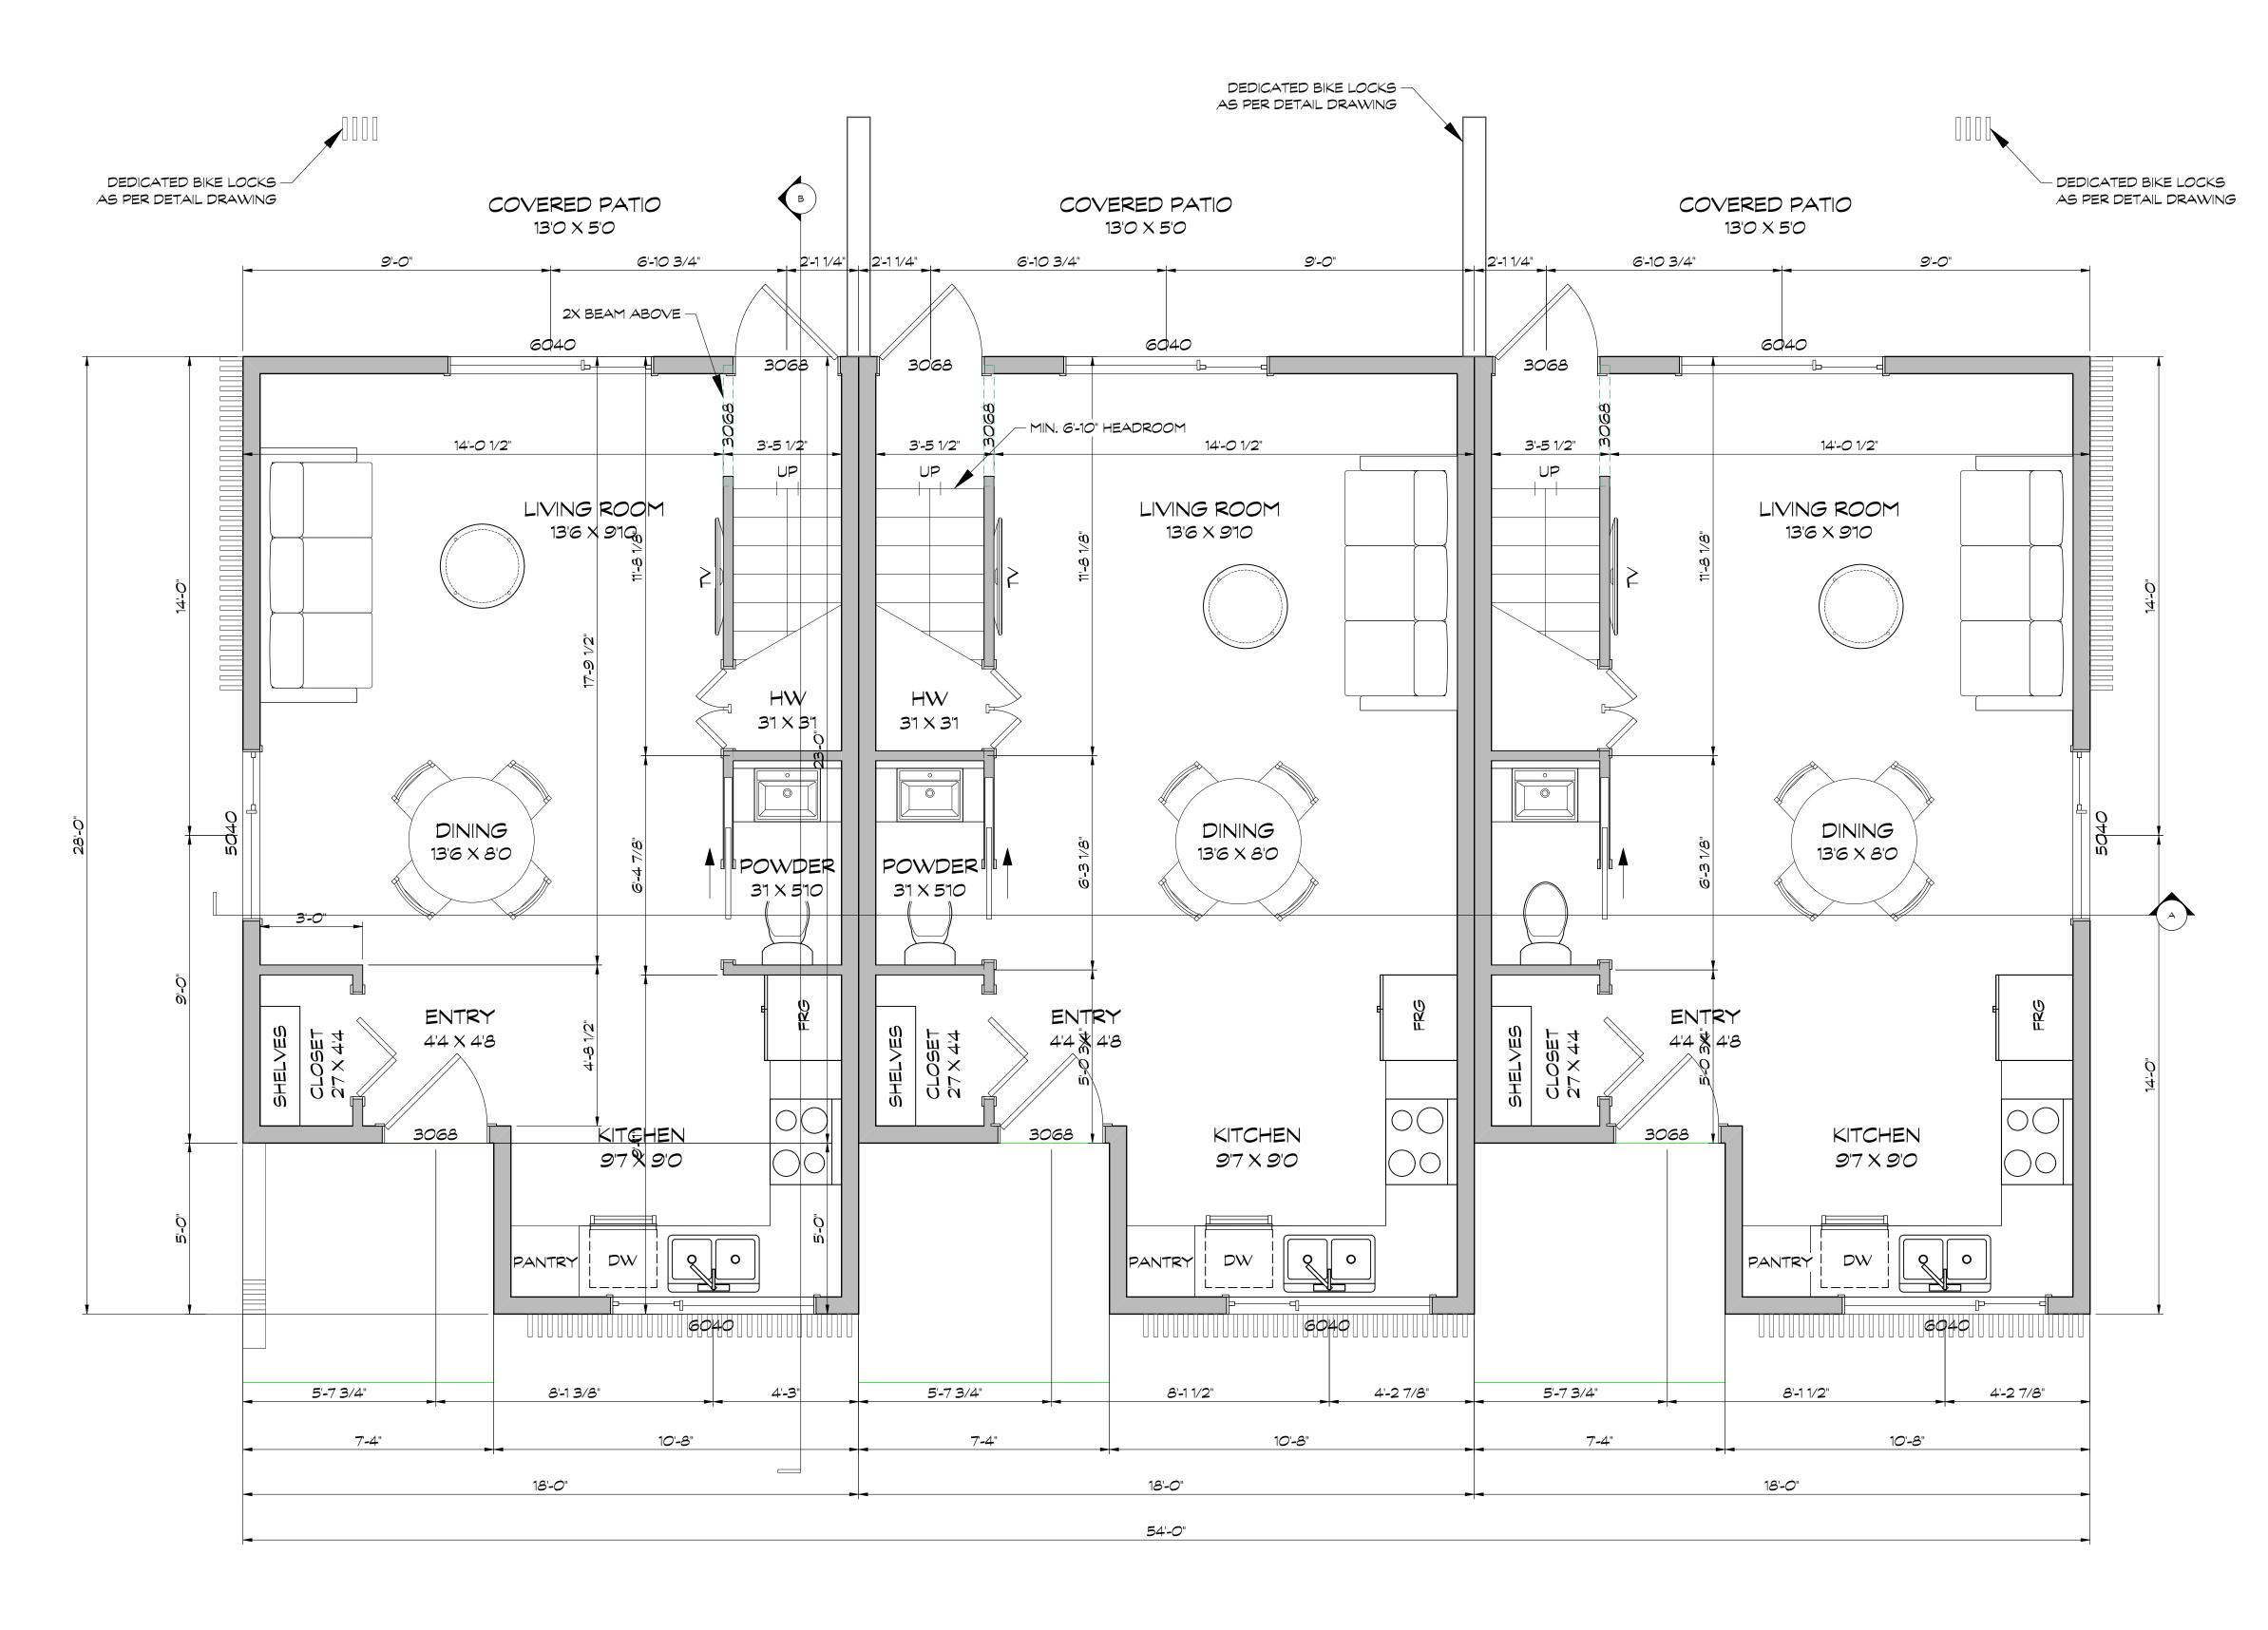
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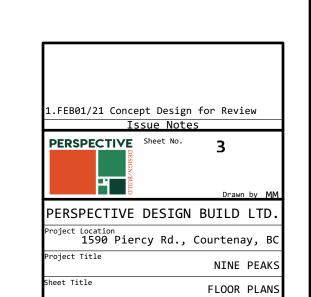





MAIN FLOOR PLAN SCALE: 3/8" = 1'-0"

ALL 3 DWELLINGS IDENTICAL DIMENSIONS
467 SQ FT (EXTERIOR FLOOR AREA PER DWELLING)
51 SQ FT (ENTRY SLAB PER DWELLING)

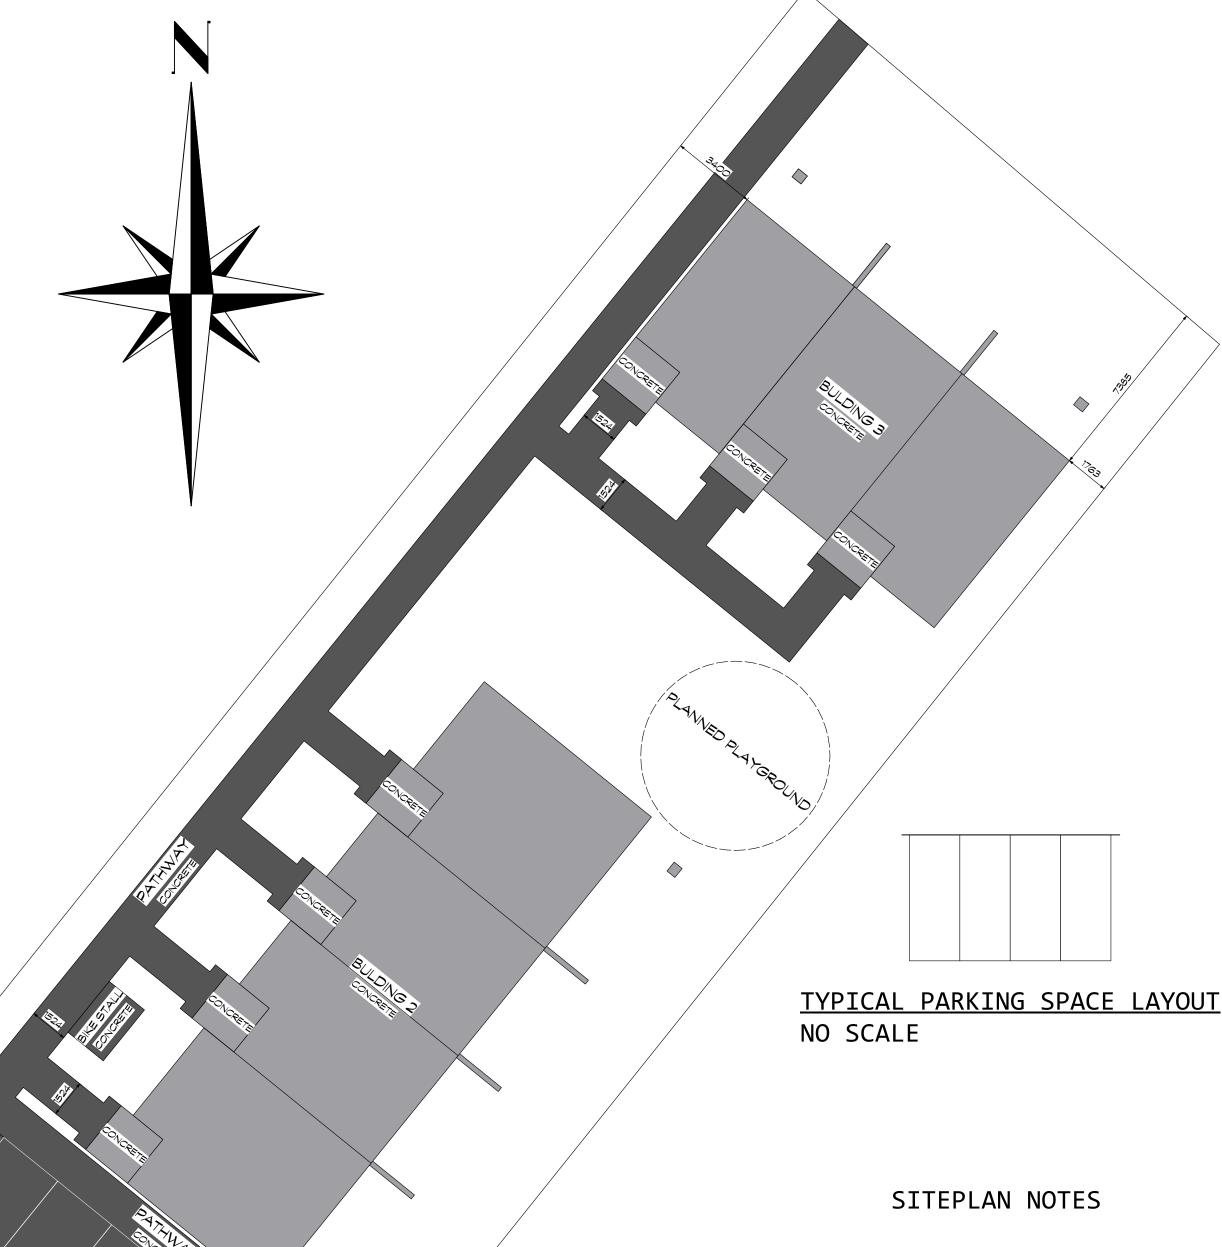1402 SQ FT (EXTERIOR FLOOR AREA IN TOTAL PER BUILDING) 153 SQ FT (ENTRY SLABS IN TOTAL PER BUILDING)




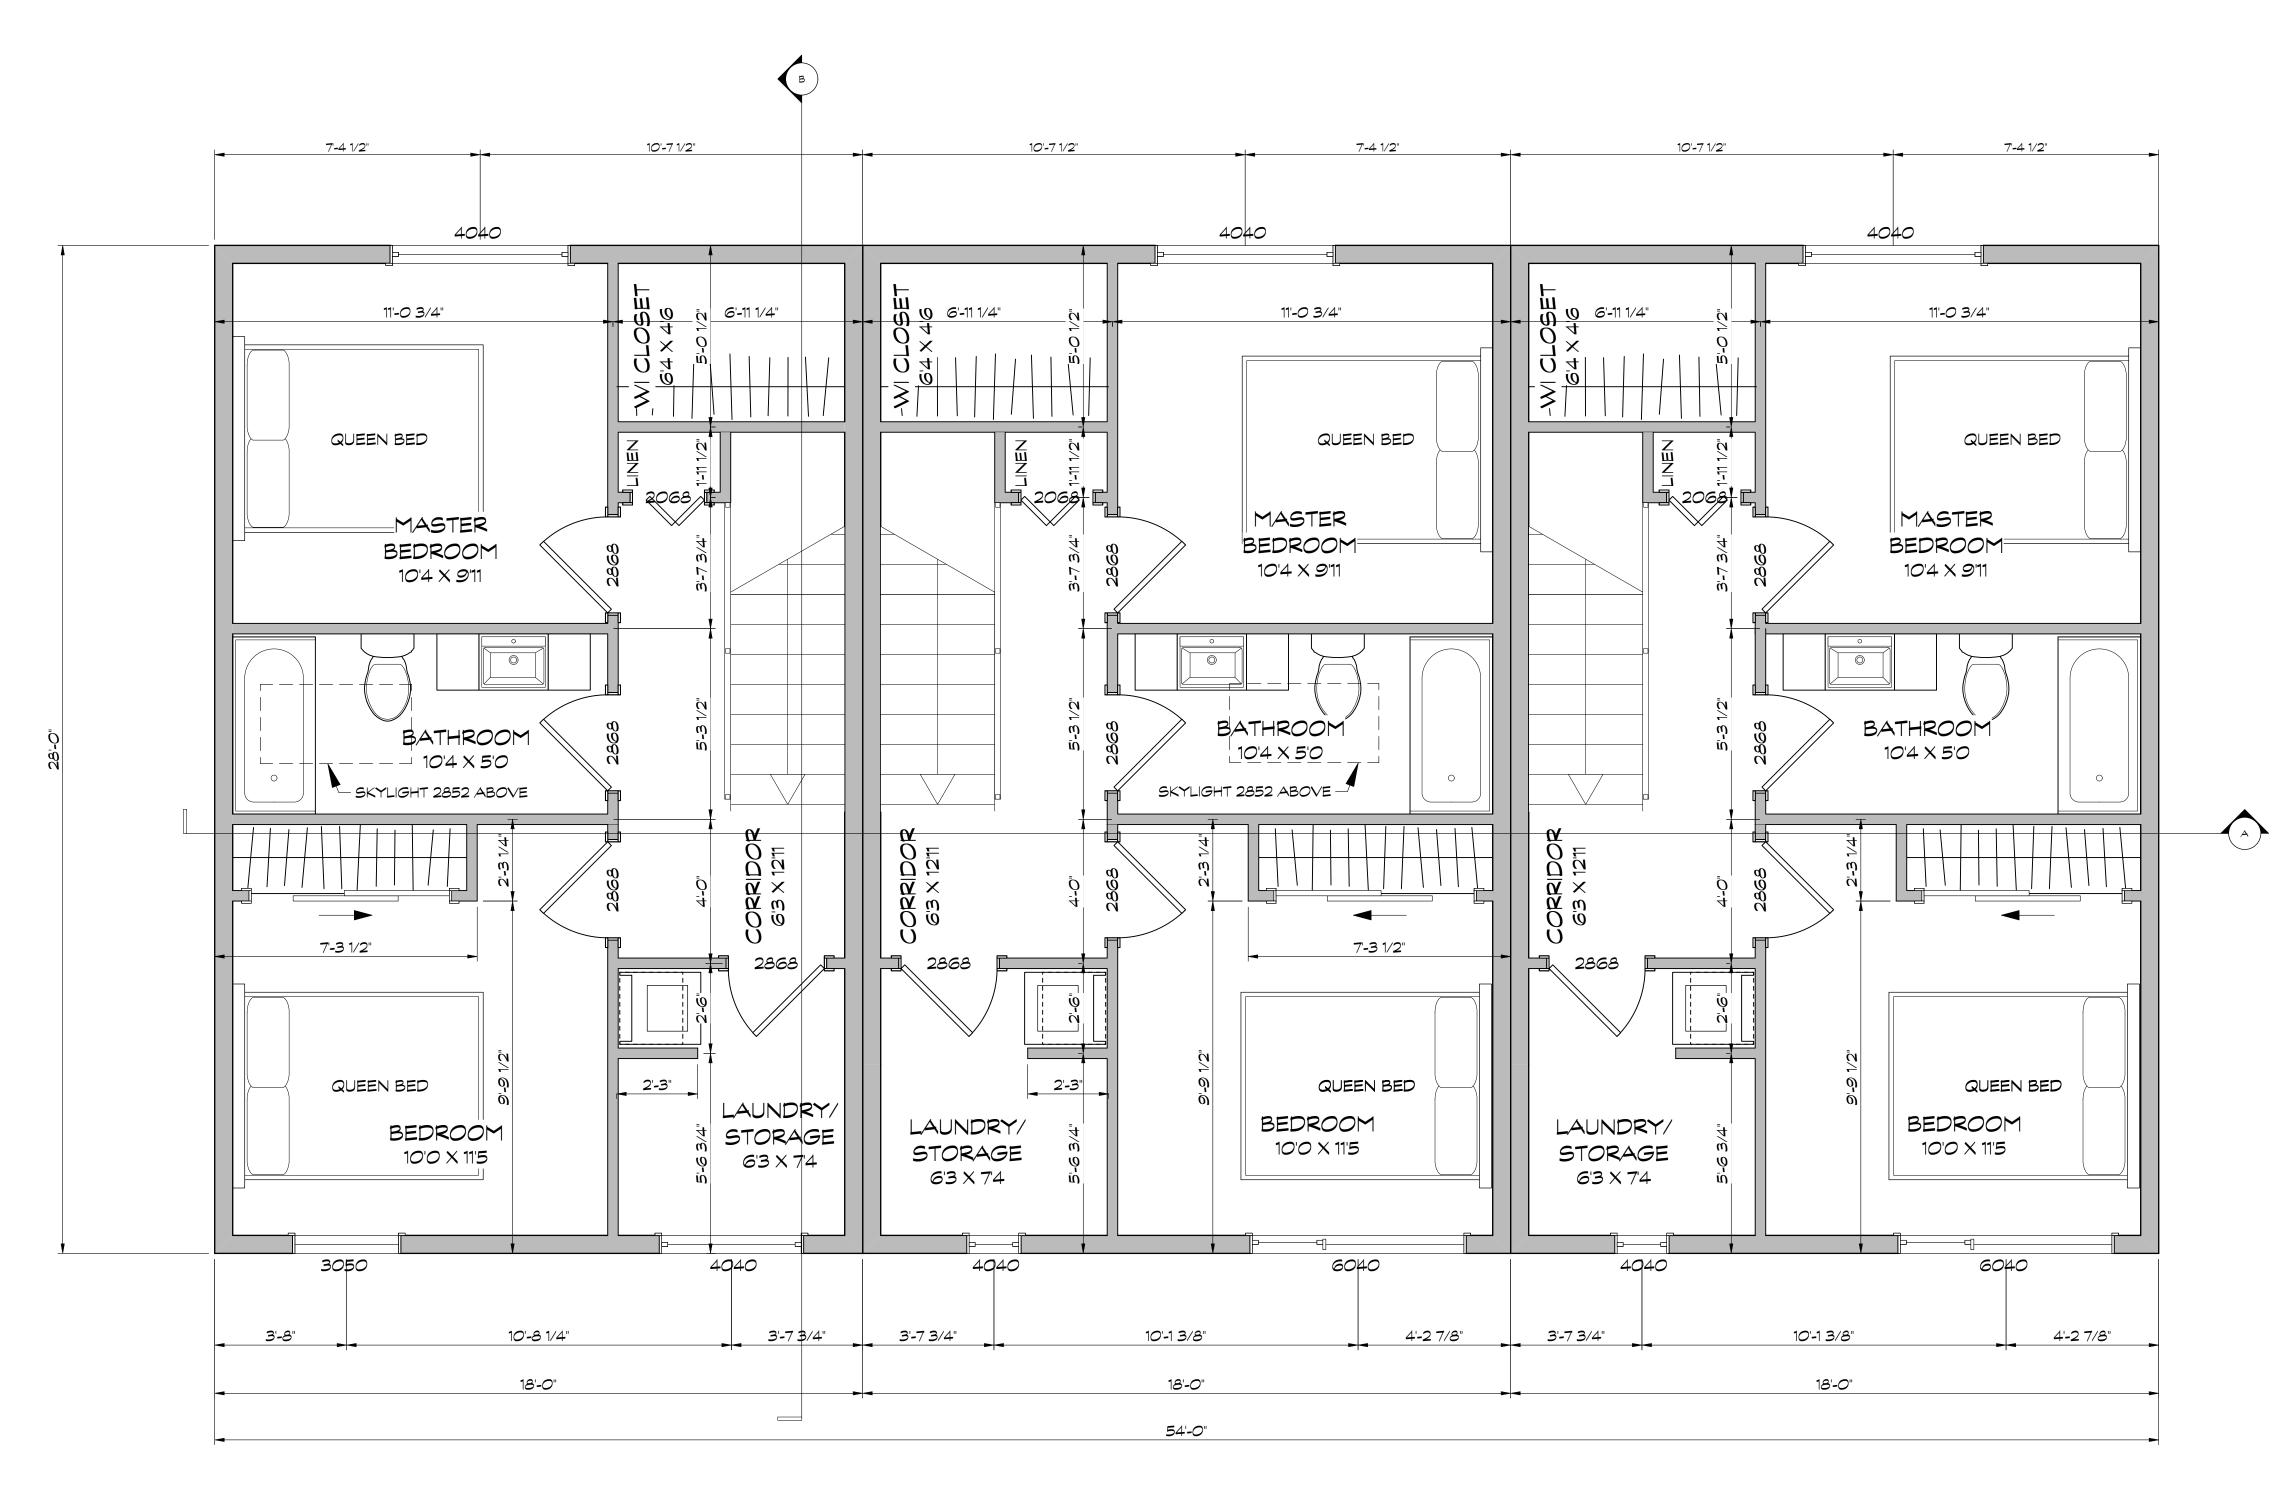



<u>UPPER FLOOR PLAN</u> SCALE: 3/8" = 1'-0"

472 SQ FT (EXTERIOR FLOOR AREA IN PER DWELLING)

1445 SQ FT (EXTERIOR FLOOR AREA IN TOTAL PER BUILDING)

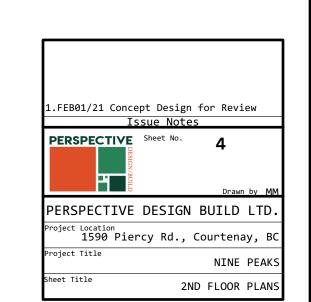

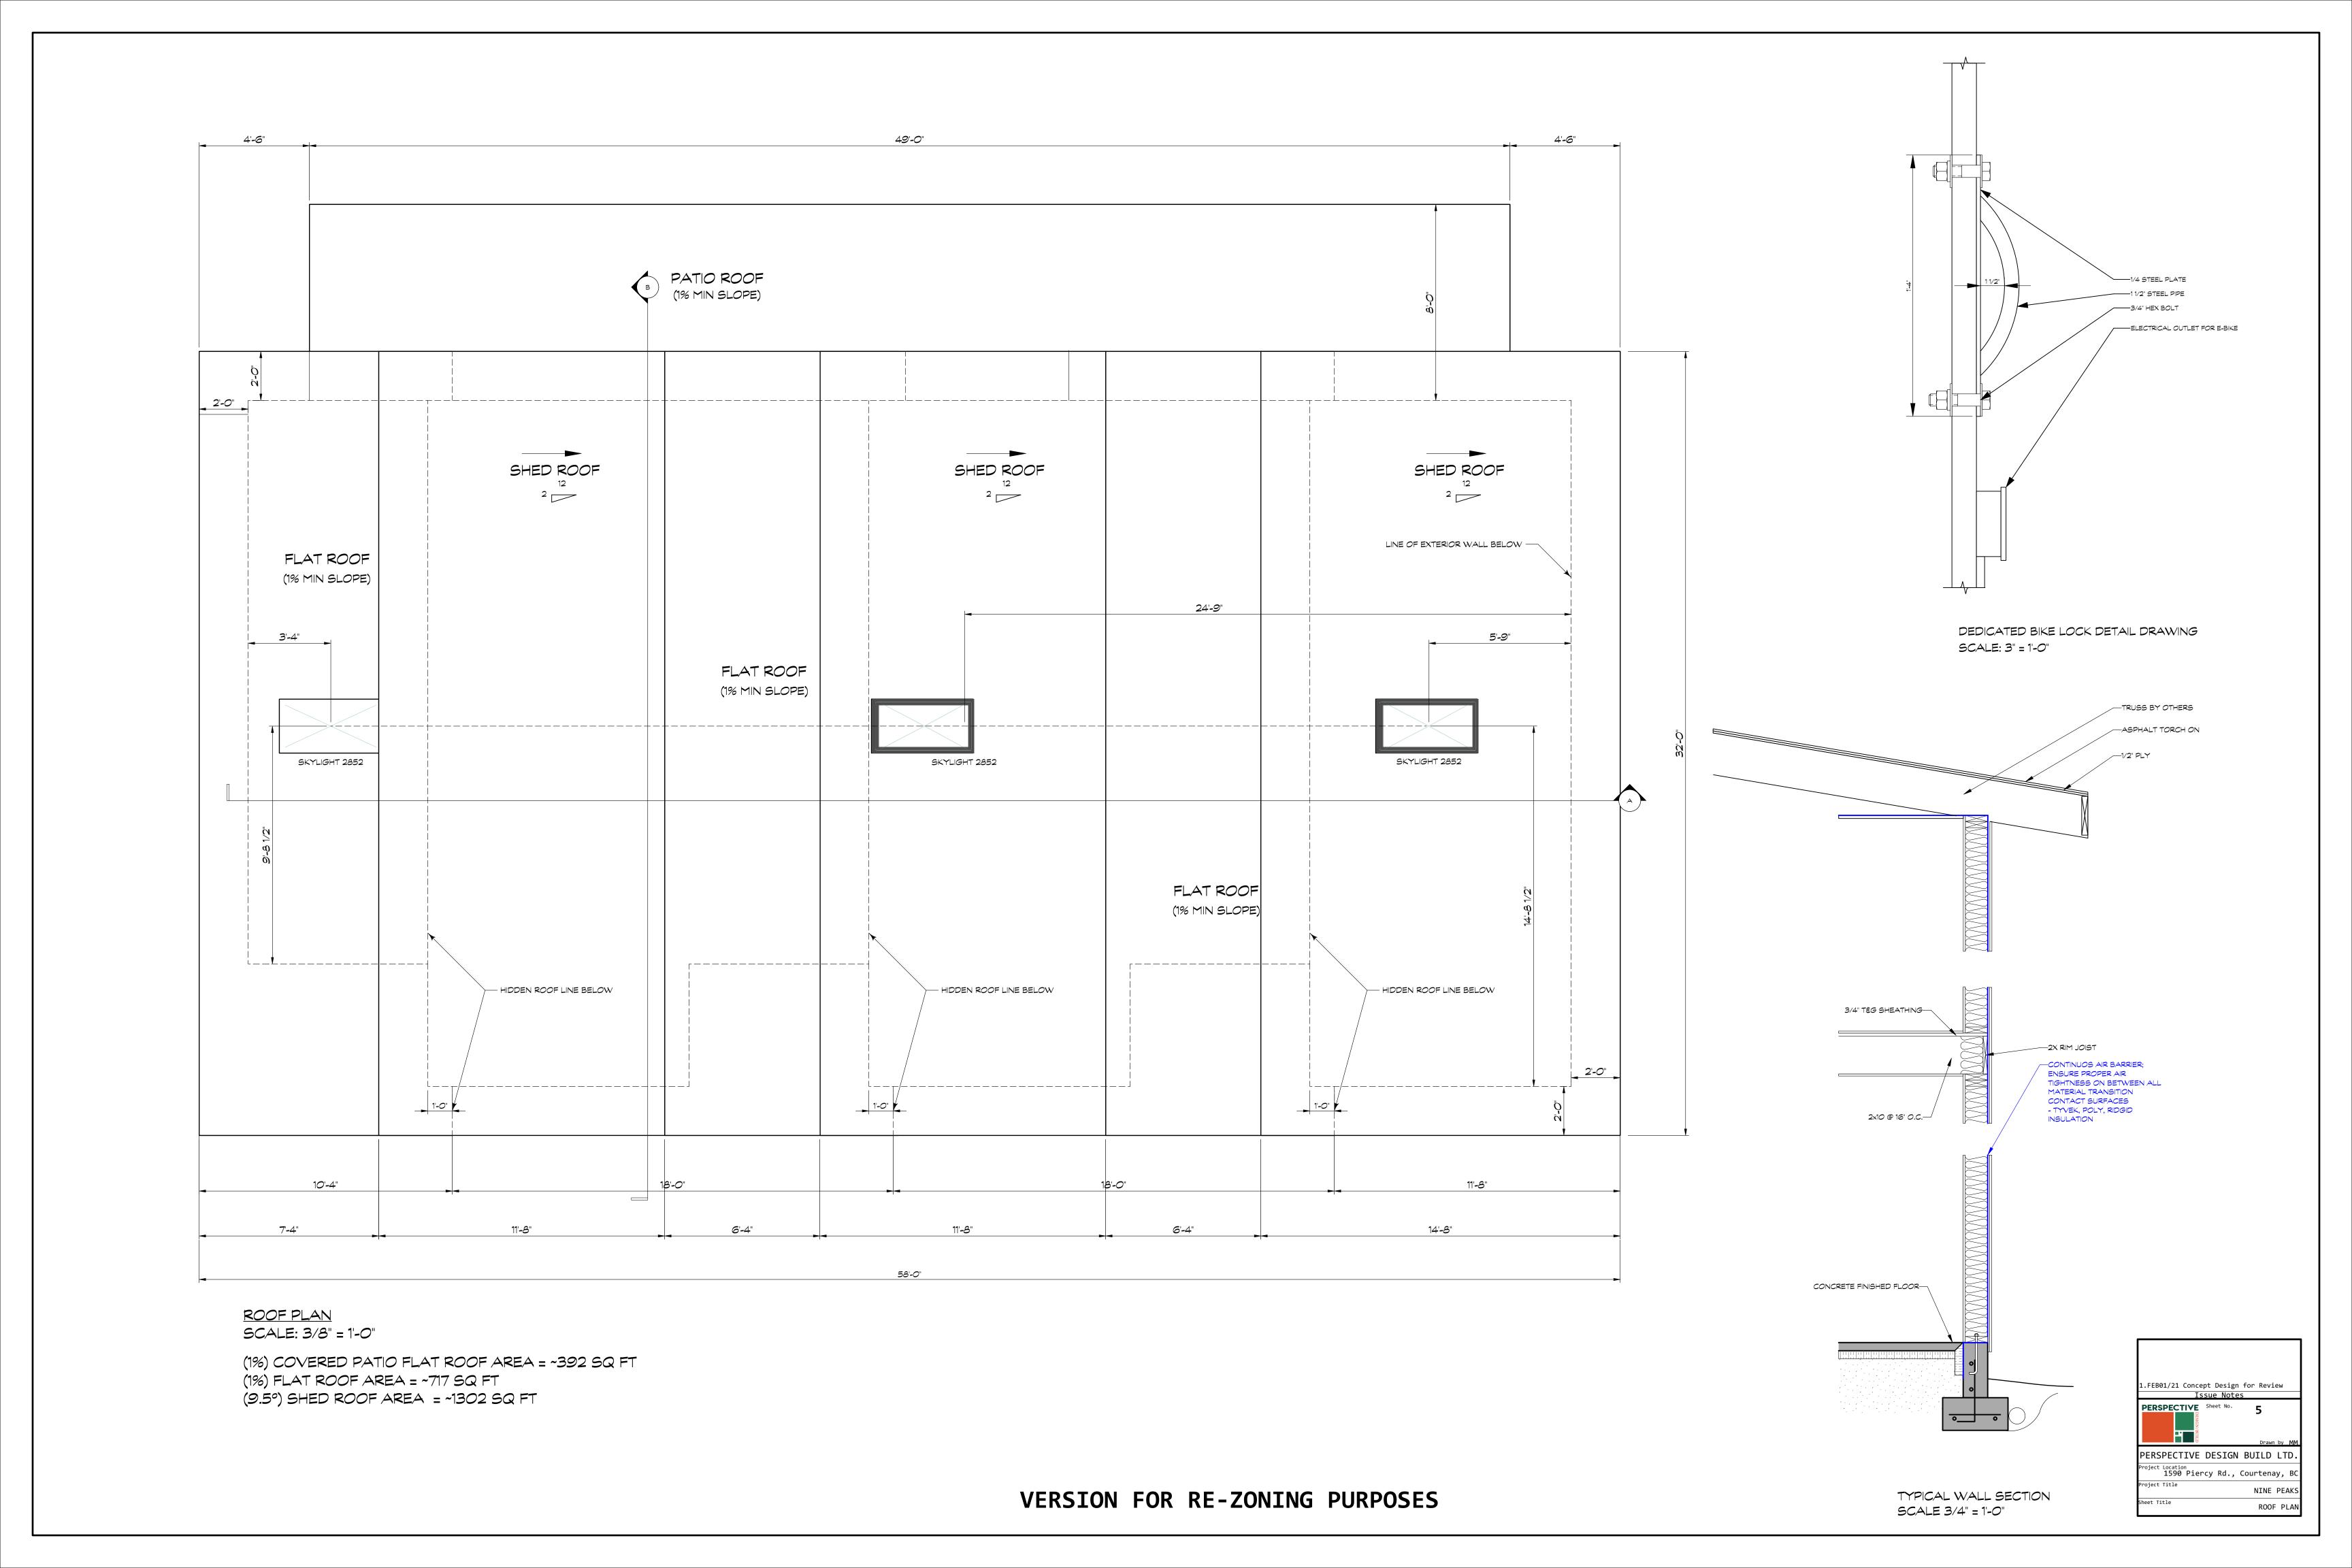

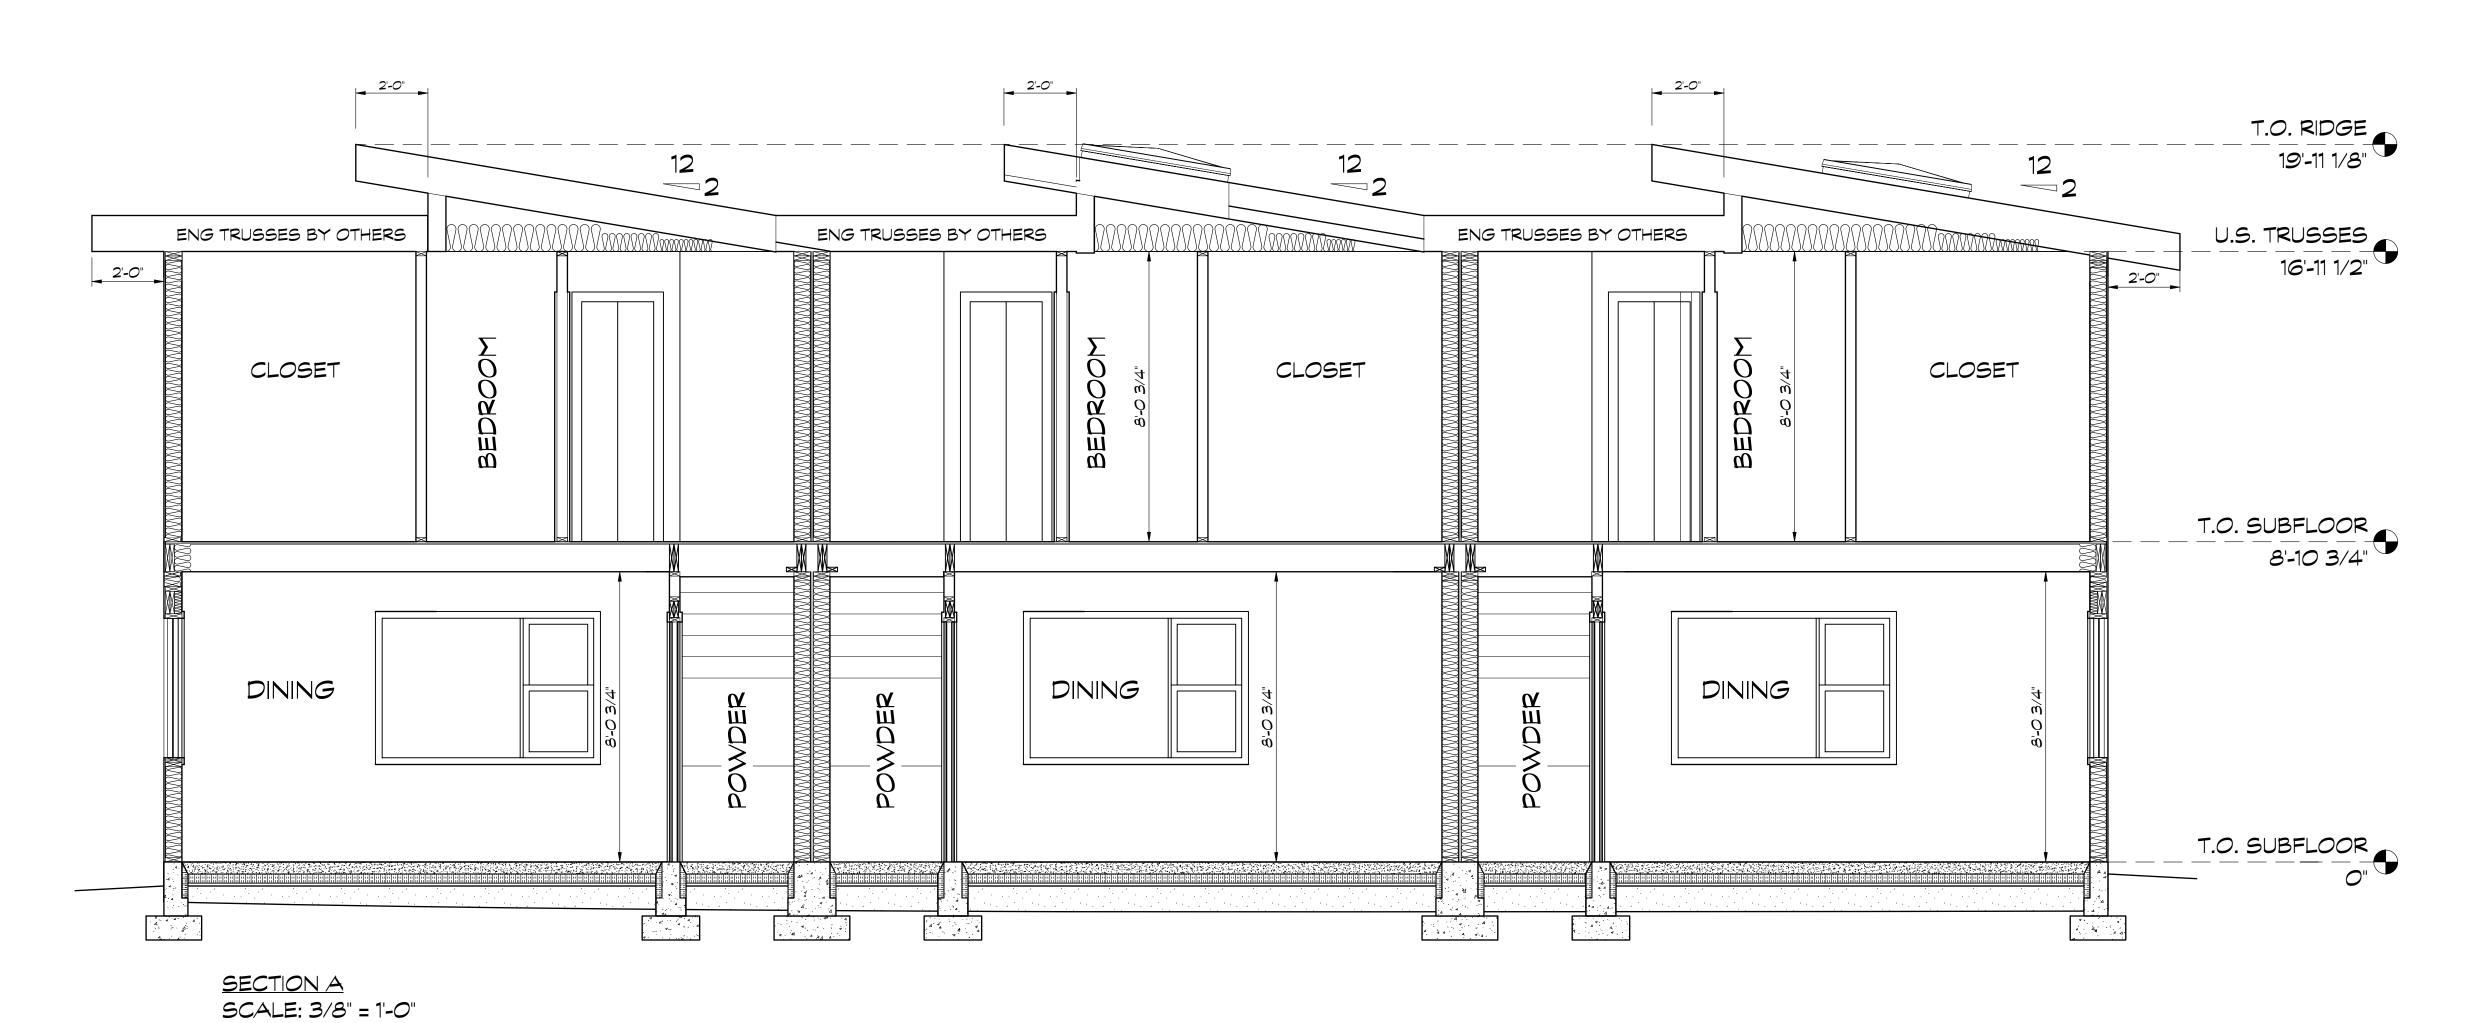

SEALED POLYETHYLENE AIR BARRIER - CODE REFERENCES 9.36.2.9. AIR TIGHTNESS

9.36.2.10. CONSTRUCTION OF AIR BARRIER DETAILS

ENSURE AIR BARRIER IS CONTINUOUS AND AIR TIGHT AT: - PARTITION WALLS AT EXTERIOR WALLS AND CEILING

- RECESSED LIGHTS

- DRYER AND RANGE HOOD EXHAUSTS

- EXTERIOR DOOR AND WINDOW PENETRATIONS - BATHROOM CEILING FANS


- PLUMBING PENETRATIONS

- MECHANICAL PENETRATIONS

- INTERIOR AND EXTERIOR ELECTRICAL PENETRATIONS

- RIM JOISTS

- FOUNDATION WALL TRANSITION

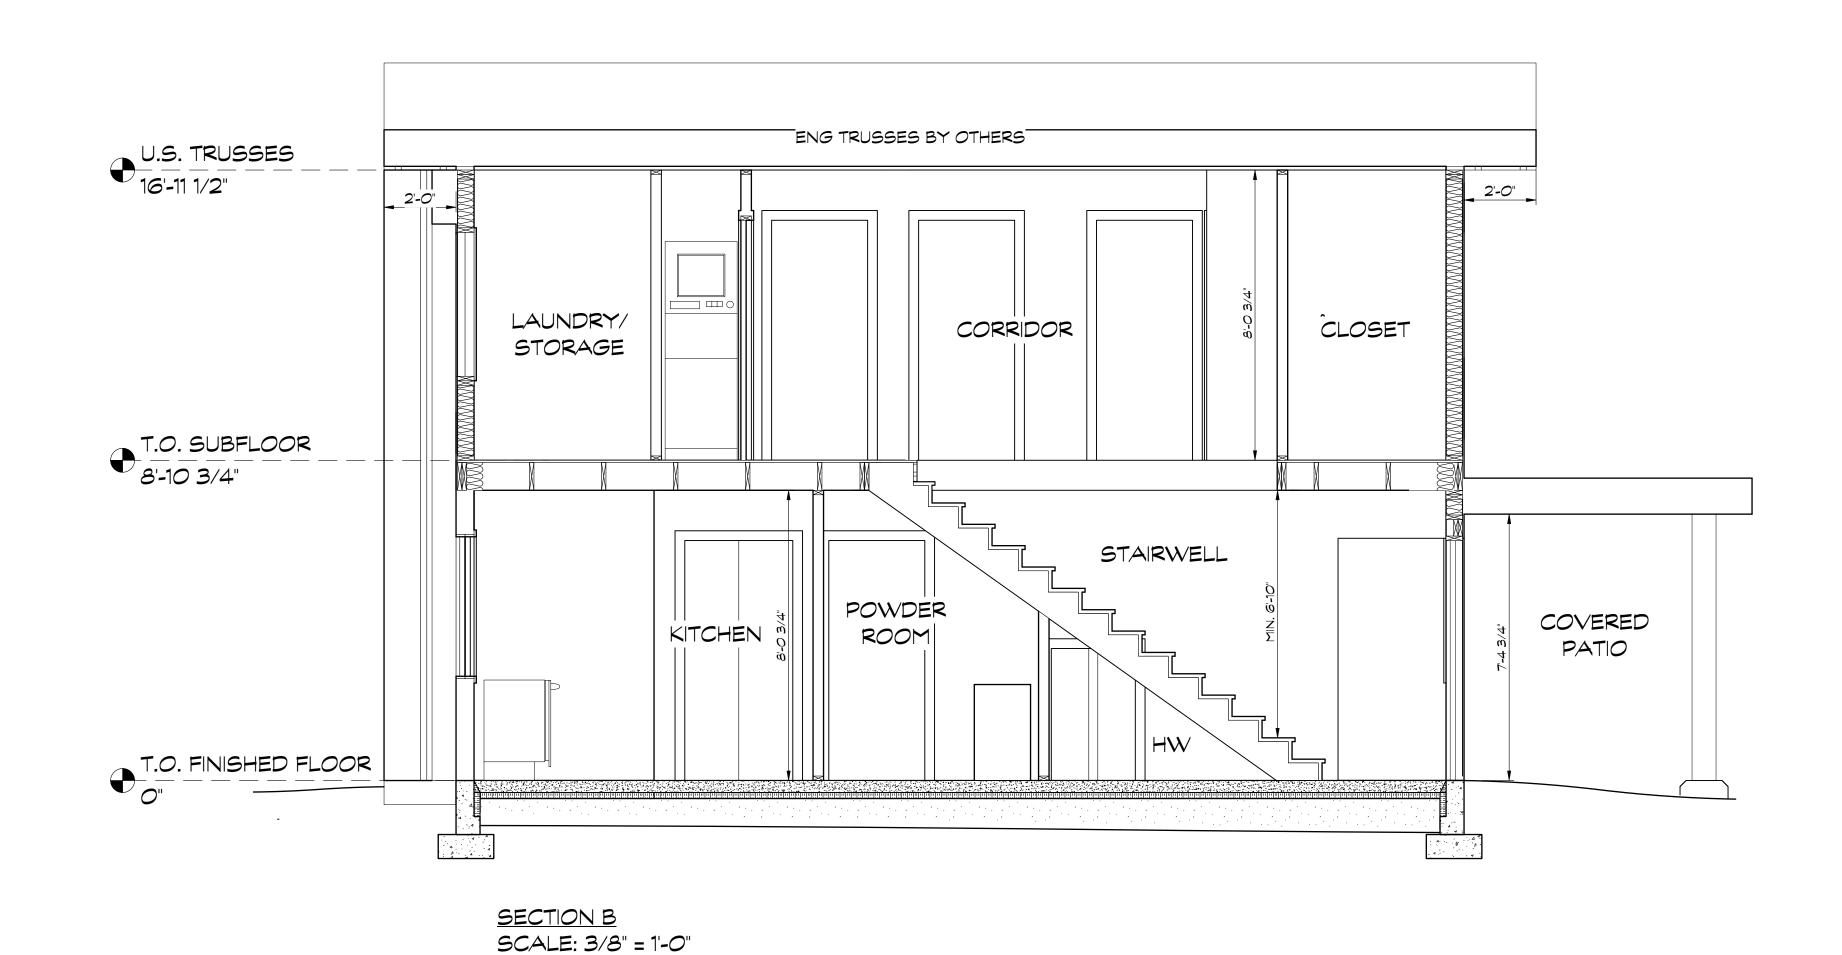

VERSION FOR RE-ZONING PURPOSES

1.FEB01/21 Concept Design for Review

Issue Notes

PERSPECTIVE Sheet No. 6

Drawn by MM

PERSPECTIVE DESIGN BUILD LTD.

Project Location
1590 Piercy Rd., Courtenay, BC

Project Title NINE PEAKS


SECTIONS






Right Elevation- not to scale



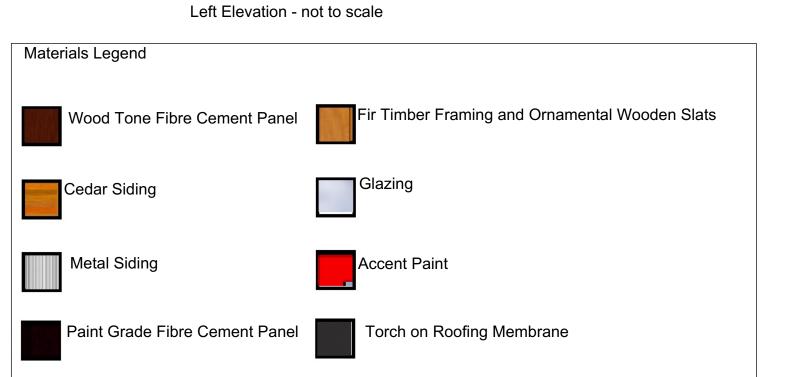



Rear Elevation- not to scale

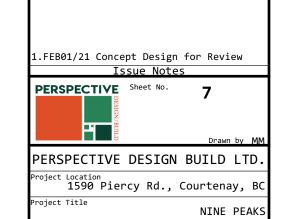

ELEVATIONS